# DEVELOPMENT APPLICATION LANDSCAPE DOCUMENTATION


# 971 RICHMOND RD, MARSDEN PARK DRAWING LIST

SHEET NO.	ISSUE	SHEET TITLE	DATE
LOO	С	COVER SHEET	29/07/21
LO1	С	LANDSCAPE SITE PLAN	29/07/21
L02	С	GROUND FLOOR / LEVEL 1 LANDSCAPE PLAN	29/07/21
L03	С	GROUND FLOOR / LEVEL 1 LANDSCAPE PLAN	29/07/21
L04	С	LEVEL 2 LANDSCAPE PLAN	29/07/21
L05	С	LEVEL 2 LANDSCAPE PLAN	29/07/21
L06	С	LEVEL 3 LANDSCAPE PLAN	29/07/21
L07	С	ROOF & LEVEL 8 LANDSCAPE PLAN	29/07/21
L08	С	PLANTING SCHEDULE	29/07/21
L09	С	PLAYGROUND	29/07/21
L10	С	STREET TREE LAYOUT PLAN	29/07/21
L11	С	STREET TREE DETAILS	29/07/21
L12	С	DETAILS & SPECIFICATION	29/07/21


#### SATELLITE VIEW




#### LOCATION MAP

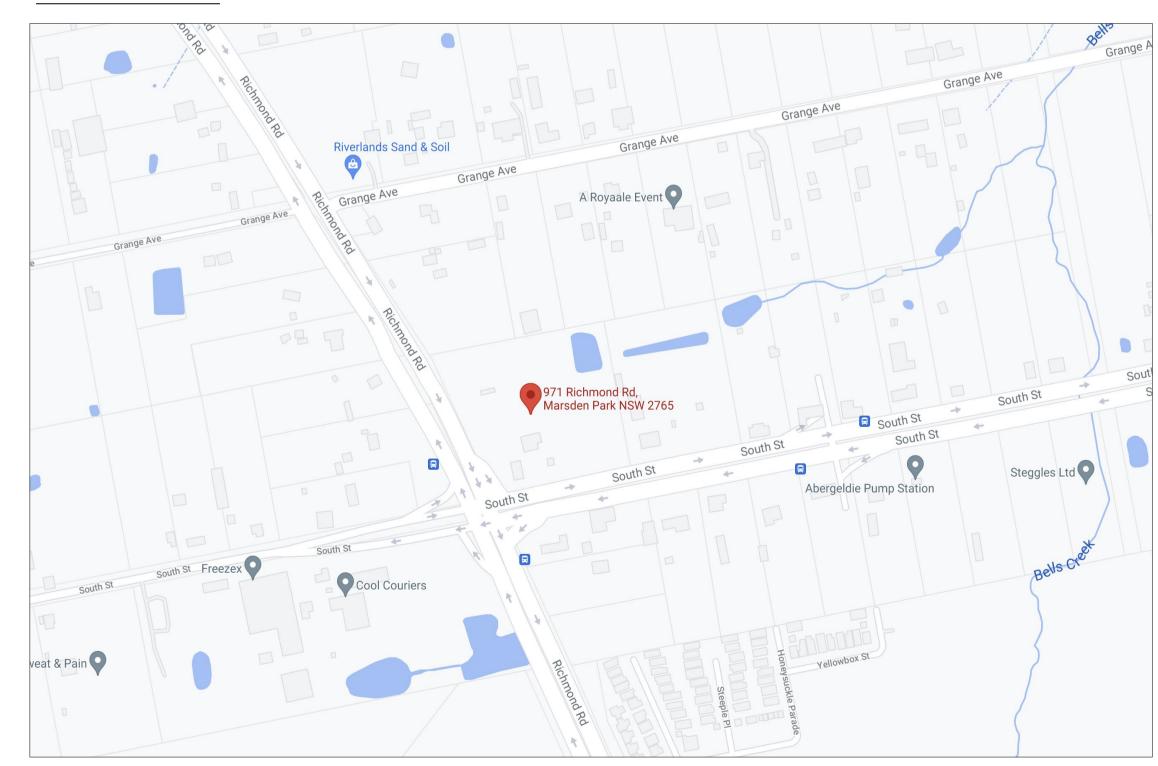



	Notes:	Legend:	COVER SHEET		Status		Project No.
				A Total Composite			ATX
			971 Richmond Rd, Marsden Park	A Total Concept Landscape Architects  & Swimming Pool Designers  65 West Street North Sydney NSW 2060	SCALE -	NTS	AIA
			Project: PROPOSED MIXED USE DEVELOPMENT	T: (02) 9957 5122 E: design@atotalconcept.com.au www.atotalconcept.com.au			Drawing No. Rev #
C 29/7/21 Amendments for the Court	oc				Drawn By GC	Dwg Date: 18.12.19	L00 C
B 27/3/20 Amendments to Playground	KR KR			CIC	Checked By JS	Plot Date: 2/8/21	LUU C
A 19/3/20 Amendments to suit Architecturals  No. Date REVISION	By		N.Patel - C/O: Architext	a total concept landscape architects & swimming pool designers	CAD File Name   MARSDEN   PARK_verD.vwx		OF 13

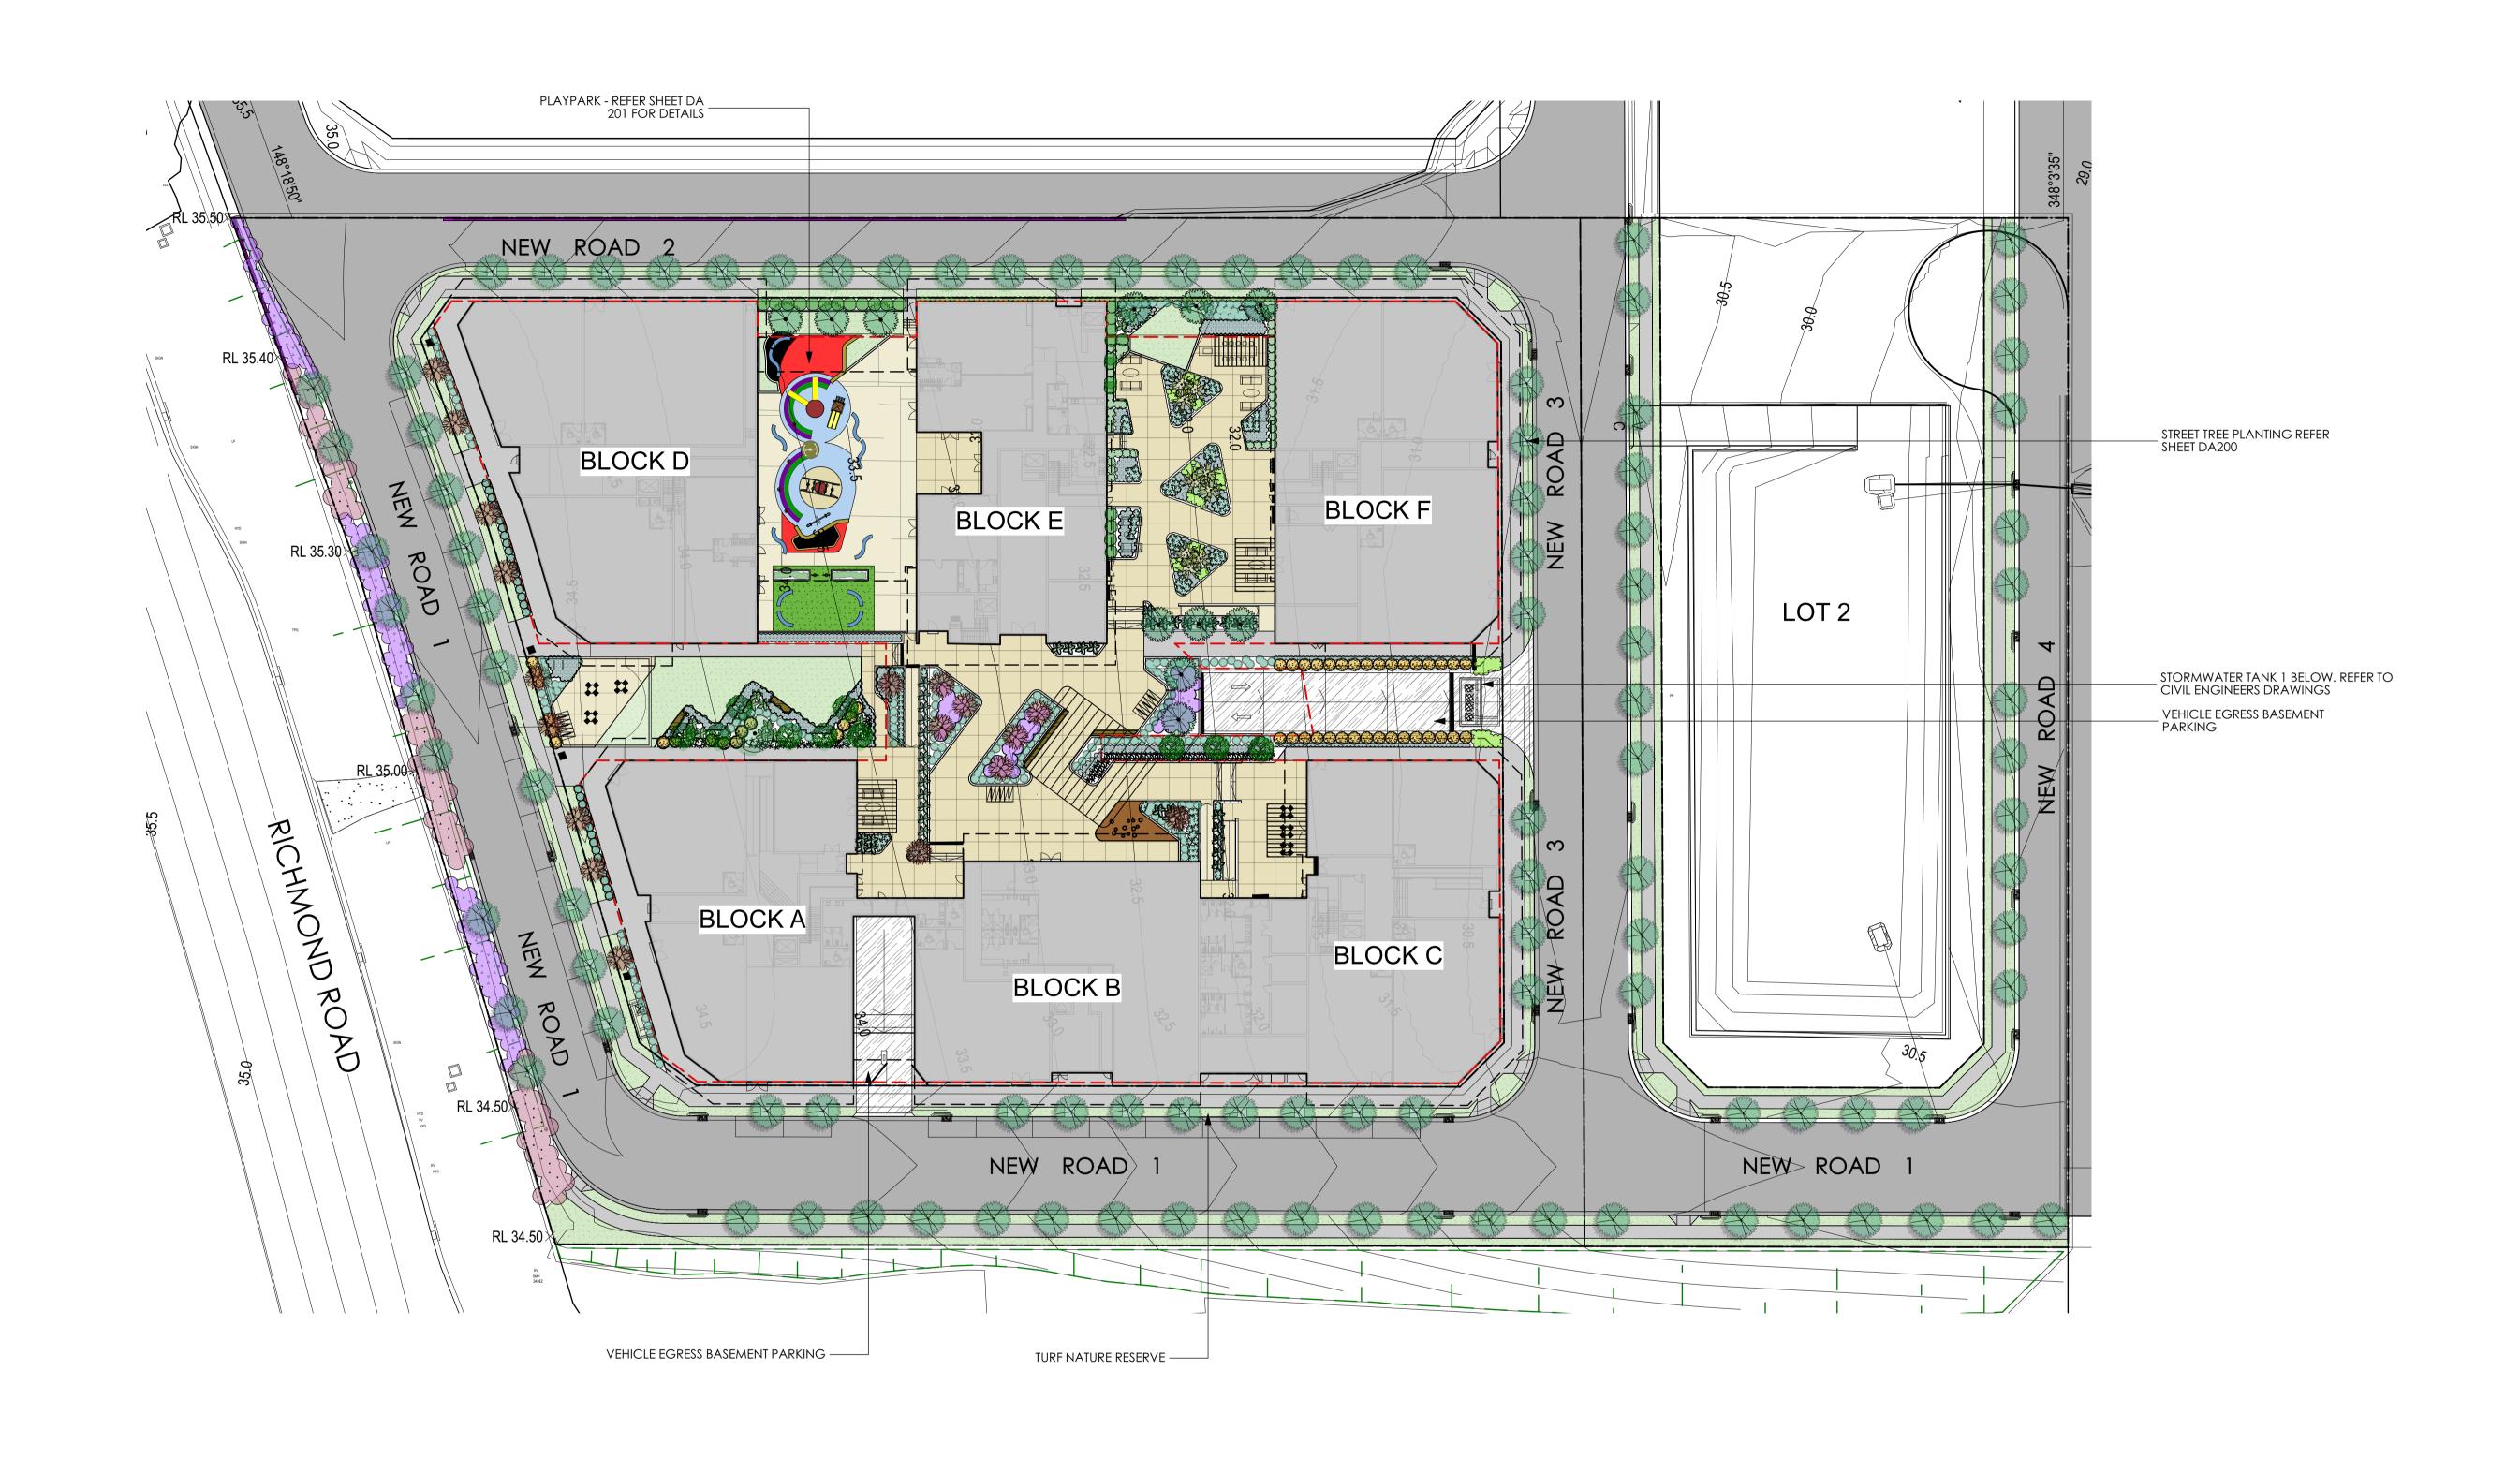

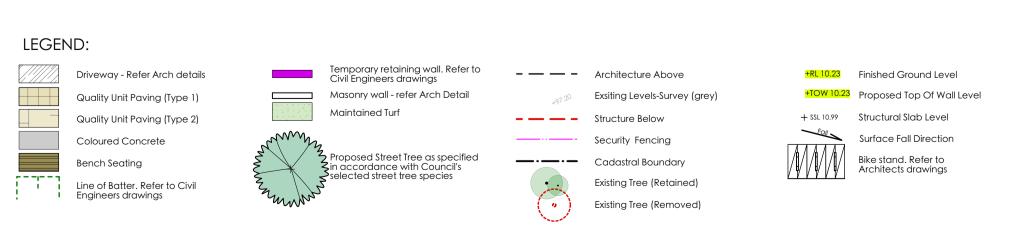

	1. All dimensions and levels shall be verified by Contractor on site prior to commencement of work  2. Do not scale from drawings.  3. If in doubt contact Landscape Architect.	LANDSCAPE SITE PLAN  Address: 971 Richmond Rd, Marsden Park	1 65 West Street, North Sydney NSW 2060	SCALE - 1:400 @ A1	Project No.  ATX
C 29/7/21 Amendments for the Court OC B 27/3/20 Amendments to Playground KR A 19/3/20 Amendments to suit Architecturals KR	<ul> <li>4. This design is copyright and shall not be copied, utilised or reproduced in any way without prior written permission of A Total Concept Landscape Architects.</li> <li>5. This plan has been prepared for Development Application purposes only.</li> <li>6. All Building Works shall be installed to Structural Engineers</li> </ul>	Project: PROPOSED MIXED USE DEVELOPMENT  Client: N.Patel - C/O: Architext	T: (02) 9957 5122 E: design@atotalconcept.com.au www.atotalconcept.com.au	Drawn By         GC         Dwg Date:         09.04.18           Checked By         SW         Plot Date:         09.04.18           CAD File Name         MARSDEN	Drawing No. Rev#  L01 C  OF 13

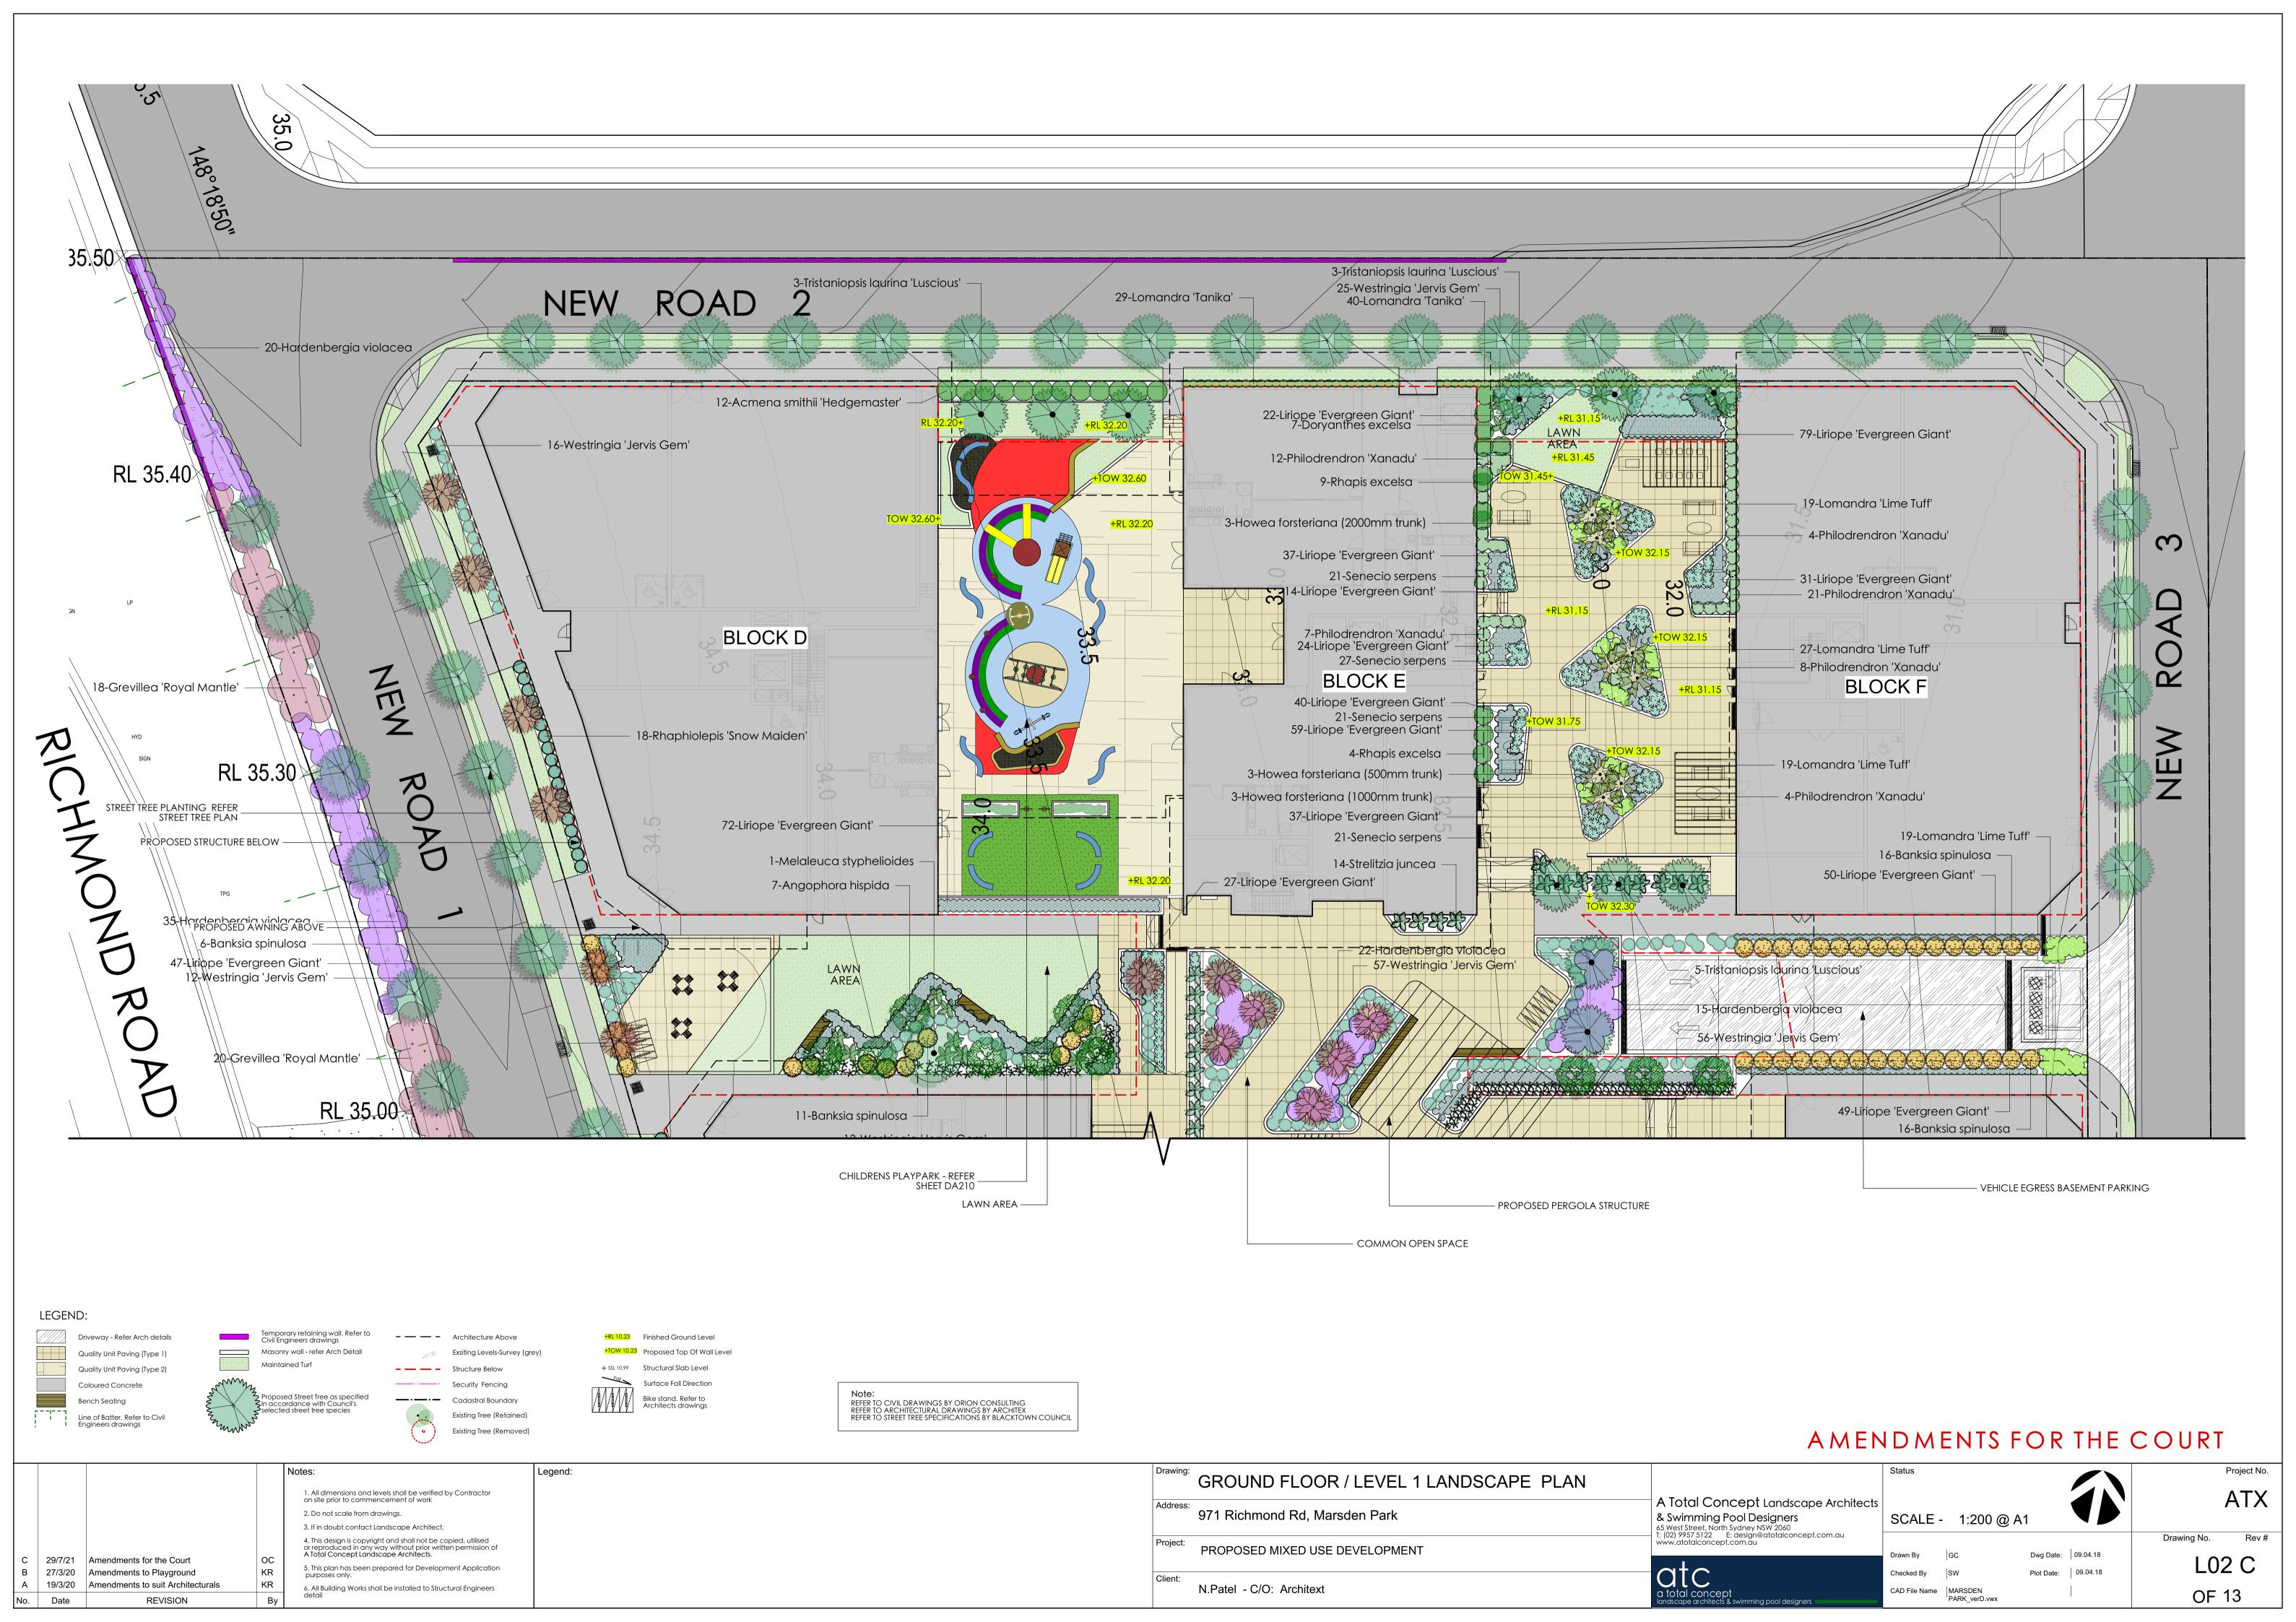

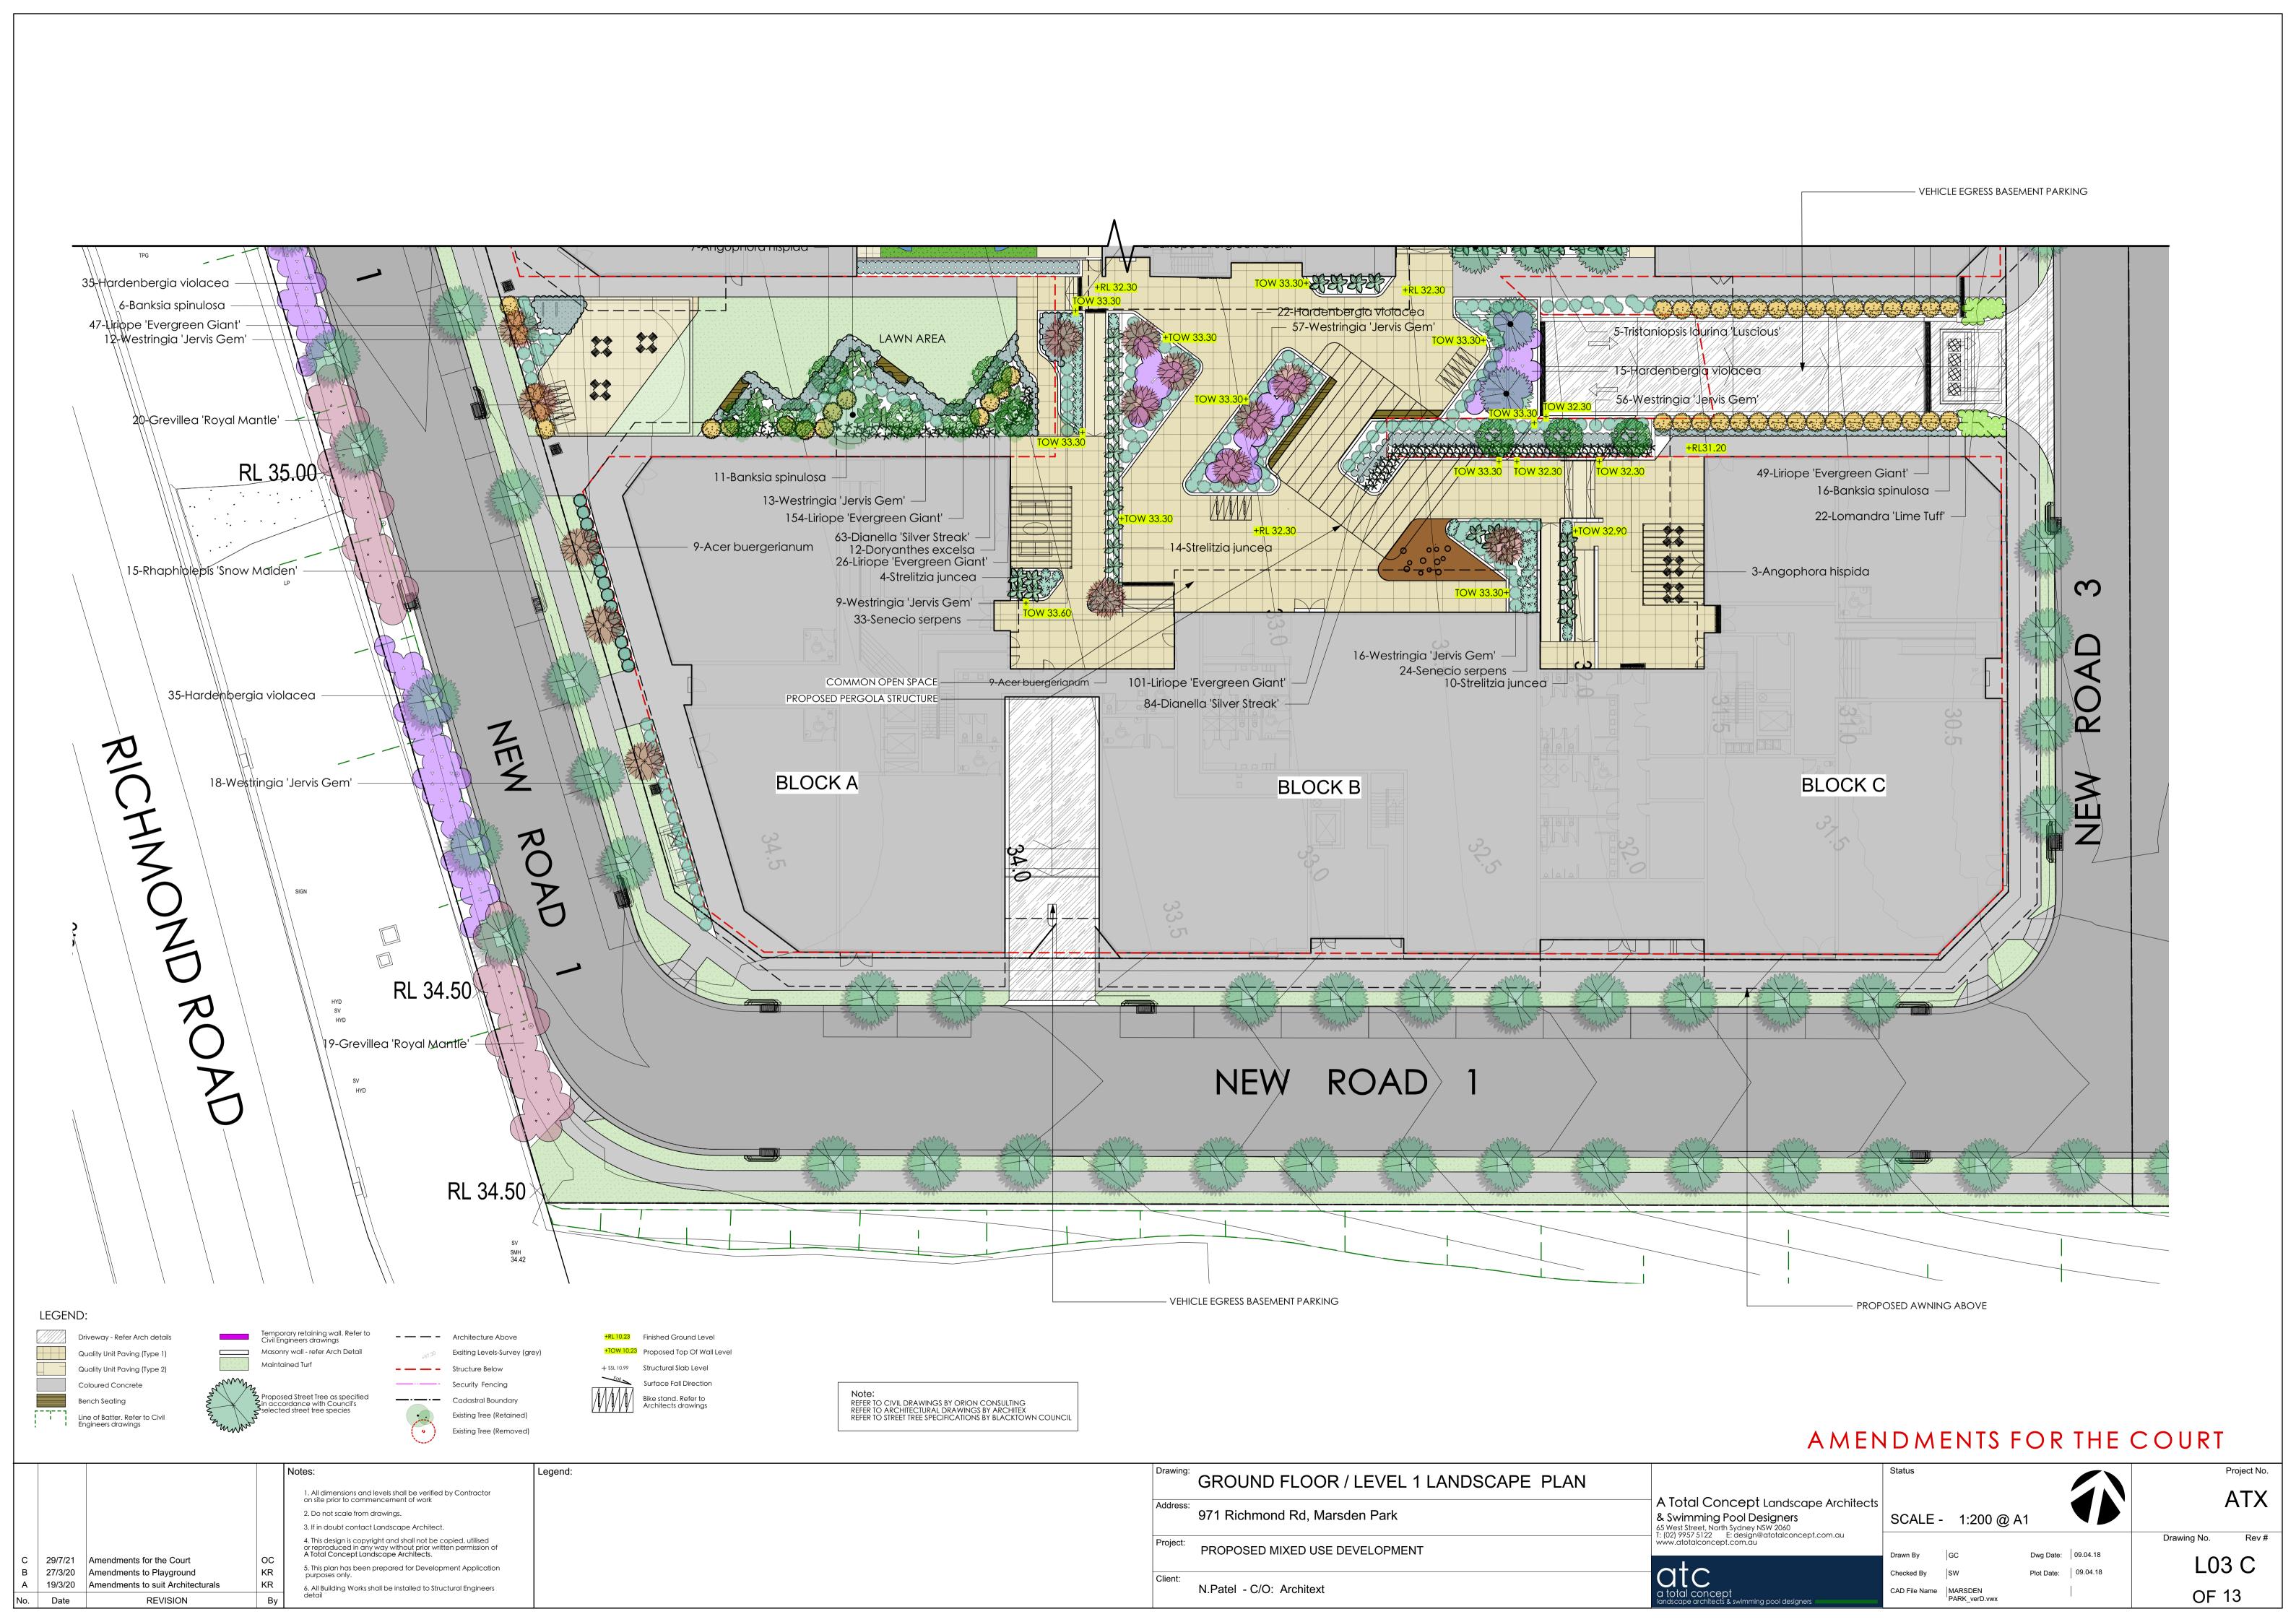



LEVEL 2 LANDSCAPE PLAN

PROPOSED MIXED USE DEVELOPMENT

971 Richmond Rd, Marsden Park

N.Patel - C/O: Architext

AMENDMENTS FOR THE COURT

Dwg Date: 09.04.18

Plot Date: 09.04.18

SCALE - 1:200 @ A1

PARK\_verD.vwx

Drawn By

Checked By SW

CAD File Name | MARSDEN

A Total Concept Landscape Architects

& Swimming Pool Designers

65 West Street, North Sydney NSW 2060

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**ATX** 

L04 C

OF 13

Drawing No.

Maintained Turf

oposed Street Tree as specified accordance with Council's elected street tree species

Notes:

KR

KR

**- — -** Structure Below

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**—·—·** Cadastral Boundary

Security Fencing

Existing Tree (Retained)

Existing Tree (Removed)

Legend:

Quality Unit Paving (Type 2)

Line of Batter. Refer to Civil Engineers drawings

29/7/21 Amendments for the Court

27/3/20 Amendments to Playground

19/3/20 Amendments to suit Architecturals

Coloured Concrete


Bench Seating

+ SSL 10.99 Structural Slab Level

Surface Fall Direction


Bike stand. Refer to Architects drawings Note:
REFER TO CIVIL DRAWINGS BY ORION CONSULTING
REFER TO ARCHITECTURAL DRAWINGS BY ARCHITEX
REFER TO STREET TREE SPECIFICATIONS BY BLACKTOWN COUNCIL



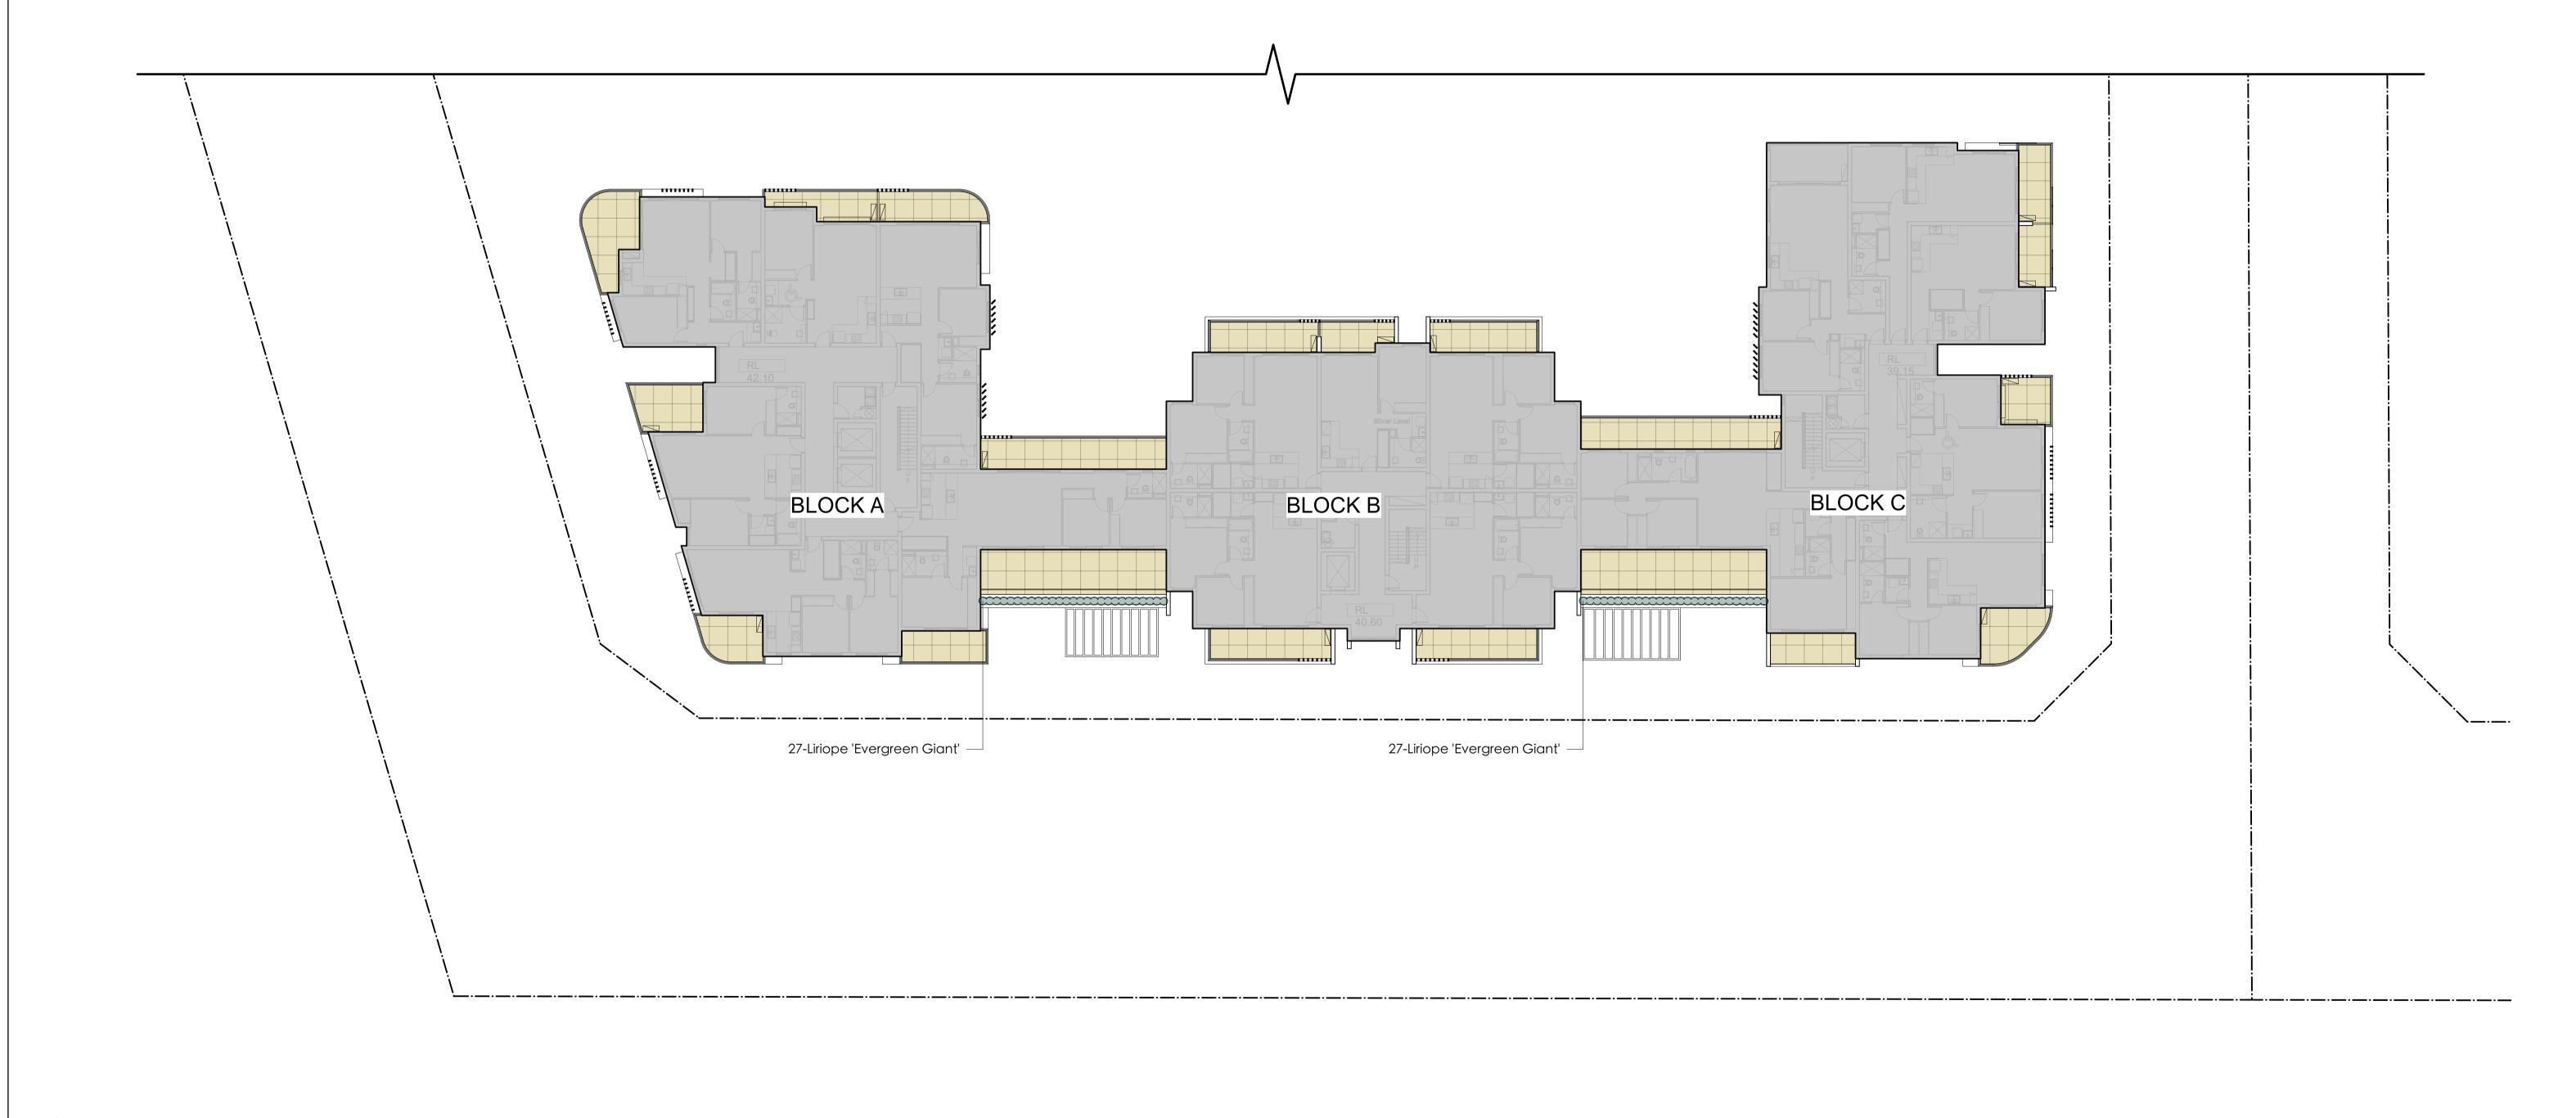








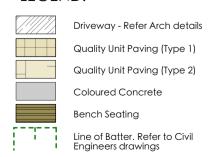





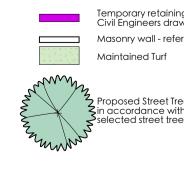

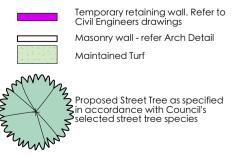

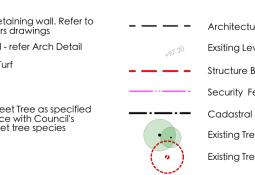


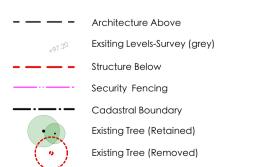

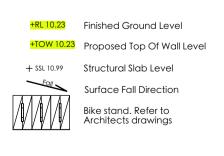

# Note: REFER TO CIVIL DRAWINGS BY ORION CONSULTING REFER TO ARCHITECTURAL DRAWINGS BY ARCHITEX REFER TO STREET TREE SPECIFICATIONS BY BLACKTOWN COUNCIL

	Notes: Legend:	Drawing: LEVEL 3 LANDSCAPE PLAN	St	ratus	Project No.
	1. All dimensions and levels shall be verified by Contractor on site prior to commencement of work  2. Do not scale from drawings.	Address: 971 Richmond Rd, Marsden Park	A Total Concept Landscape Architects & Swimming Pool Designers	SCALE - 1:200 @ A1	ATX
	3. If in doubt contact Landscape Architect.  4. This design is copyright and shall not be copied, utilised or reproduced in any way without prior written permission of A Total Concept Landscape Architects.	Project: PROPOSED MIXED USE DEVELOPMENT	65 West street, North Sydney NSW 2060 T: (02) 9957 5122	awn By GC Dwg Date: 09.04.18	Drawing No. Rev#
No. Date REVISION	5. This plan has been prepared for Development Application purposes only.  6. All Building Works shall be installed to Structural Engineers detail	Client:  N.Patel - C/O: Architext	alc	AD File Name   MARSDEN   PARK_verD.vwx	L06 OF 13

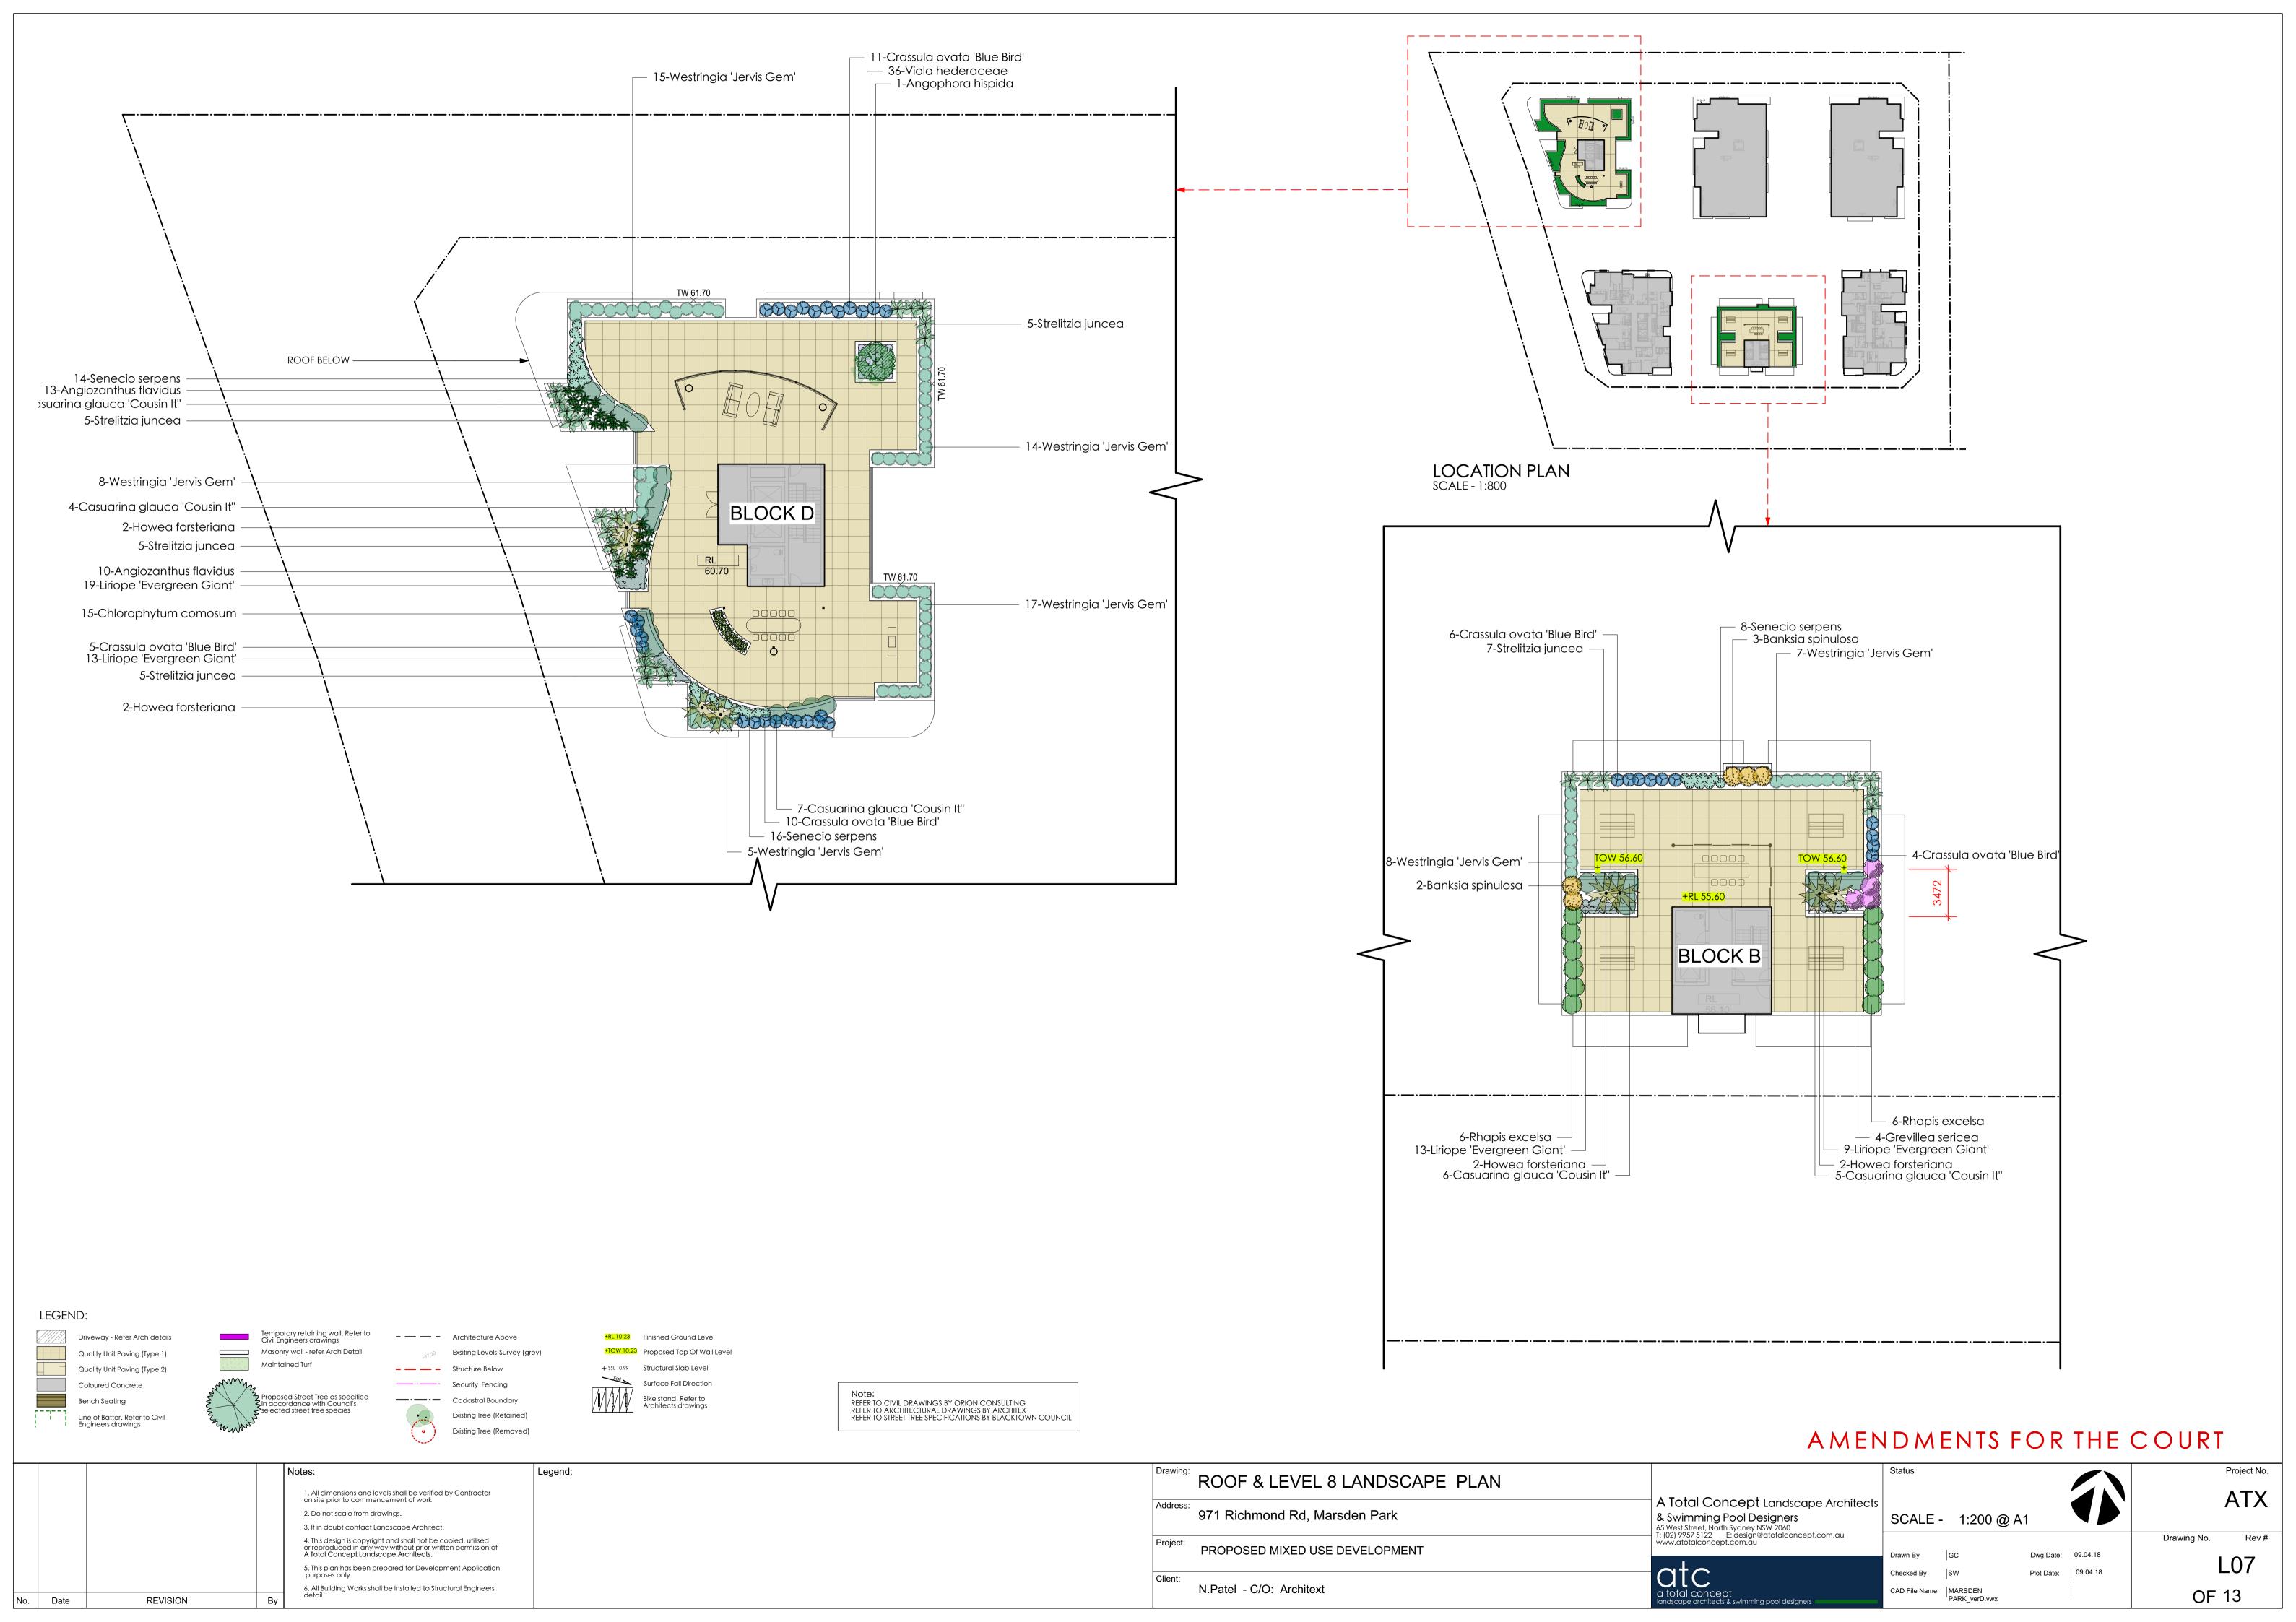


# PLANTING SCHEDULE (ENTIRE SITE)

Latin Name	Common Name	Quantity	Scheduled Size	Spread	Height
Acer buergerianum	Japanese Maple	27	75lt	3000	5500
Acmena smithii 'Hedgemaster'	Lillypilly	24	300mm	1500	2000
Angiozanthus flavidus	Kangaroo paw	113	150mm	1000	1000
Angophora hispida	Dwarf Apple	21	75lt	3000	5000
Banksia spinulosa	Hairpin Banksia	129	300mm	1500	2000
Casuarina glauca 'Cousin It"	Cousin It	26	300mm	1500	2000
Chlorophytum comosum	Spider Plant	15	150mm	600	600
Crassula ovata 'Blue Bird'	Crassula	36	150mm	1000	1000
Dianella 'Silver Streak'	Mauve Flax Lily	294	150mm	600	600
Doryanthes excelsa	Gymea Lily	38	1 <i>5</i> lt	1500	2000
Grevillea 'Bronze Rambler'	Grevillea	17	150mm	1500	300
Grevillea 'Royal Mantle'	Grevillea	114	150mm	2000	1000
Grevillea sericea	Pink Spider Flower	23	150mm	1500	2000
Hardenbergia violacea	Flase Sarsparilla	276	tube	1500	400
Howea forsteriana	Kentia Palm	11	45lt	3000	15000
Howea forsteriana (500mm trunk)	Kentia Palm	6	45lt	3000	15000
Howea forsteriana (1000mm trunk)	Kentia Palm	6	45lt	3000	15000
Howea forsteriana (2000mm trunk)	Kentia Palm	6	45lt	3000	15000
Liriope 'Evergreen Giant'	Giant Lilyturf	2232	tube	500	500
Lomandra 'Lime Tuff'	Dwarf Lomandra	278	tube	600	600
Lomandra 'Tanika'	Dwarf Lomandra	138	tube	600	600
Melaleuca styphelioides	Prickley Leaved Paperbark	2	75lt	4500	10000
Philodrendron 'Xanadu'	Dwarf Philodendron	112	150mm	1000	1000
Rhaphiolepis 'Snow Maiden'	Indian Hawthorn	66	150mm	1000	1000
Rhapis excelsa	Purple Leaved Prunus	97	300mm	1500	2000
Senecio serpens	Chalk Sticks	332	150mm	750	300
Strelitzia juncea	Bird of Paradise	111	15lt	1500	2000
Tristaniopsis laurina 'Luscious'	Kanooka, Water Gum	17	75lt	4000	7000
Viola hederaceae	Native Violets	36	tube	500	300
Westringia 'Jervis Gem'	Coastal Rosemary	678	150mm	1000	1000

NOTES: STREET TREES NOT LISTED ON PLANT SCHEDULE

Liriope 'Evergreen Giant'

Anigozanthos flavidus

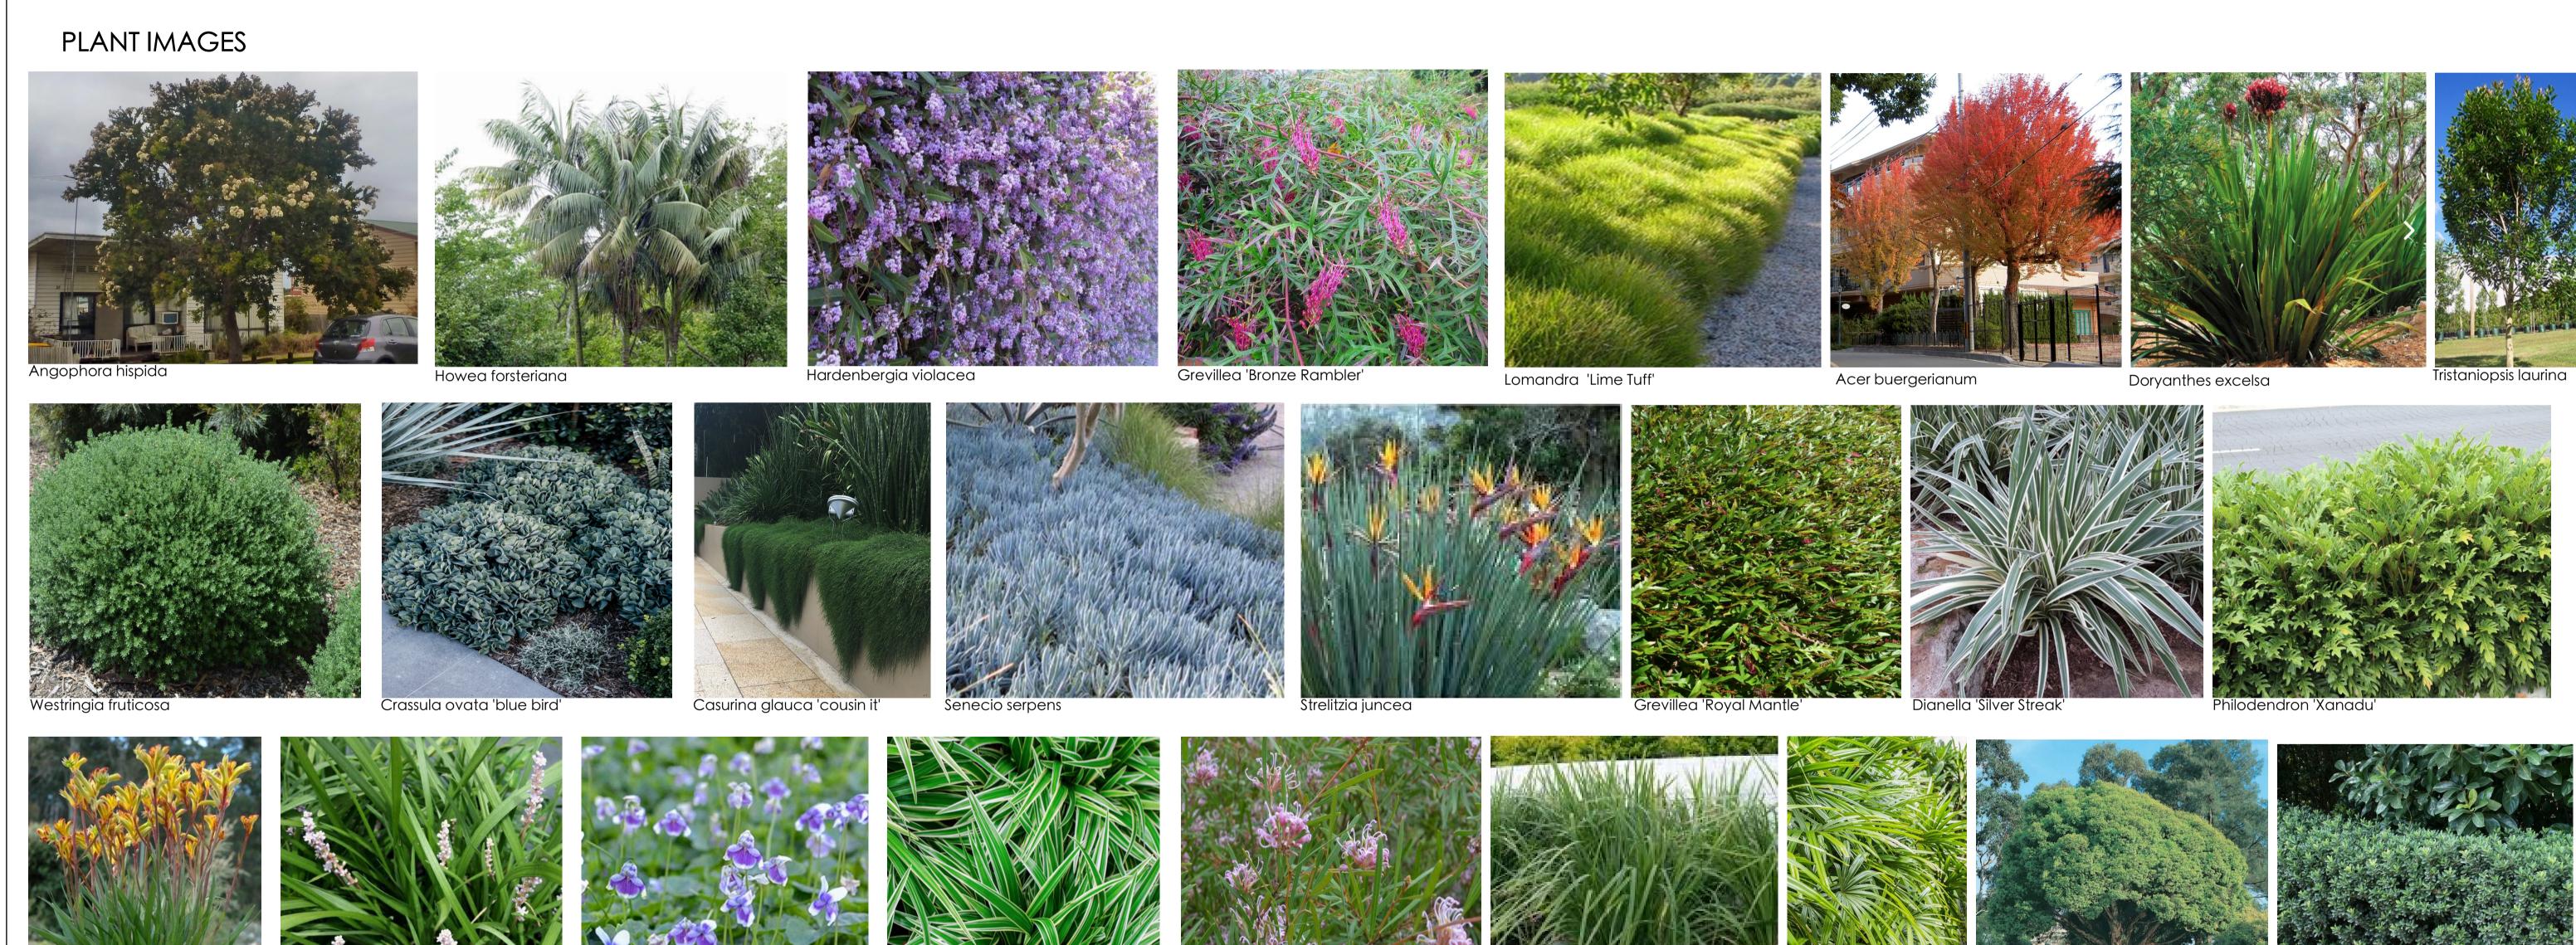

### AMENDMENTS FOR THE COURT

Melaleuca stypheliodes


Rhaphiolepis 'Snow Maiden'

		A IN L	NDMENTS FOR THE	COUKI
	Notes: Legend:	PLANTING SCHEDULE	Status	Project No.
	All dimensions and levels shall be verified by Contractor     on site prior to commencement of work	A Total Concept Landscape Architec	ts	ATX
	2. Do not scale from drawings.	971 Richmond Rd, Marsden Park & Swimming Pool Designers	SCALE -	
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	5. This plan has been prepared for Development Application purposes only.	Client <sup>-</sup>	Checked By SW Plot Date: 09.04.18	L08
No. Date REVISION	6. All Building Works shall be installed to Structural Engineers detail	Client:  N.Patel - C/O: Architext  a total concept landscape architects & swimming pool designers	CAD File Name   MARSDEN   PARK_verD.vwx	OF 13

Chlorophytum comosum

Lomandra longifolia



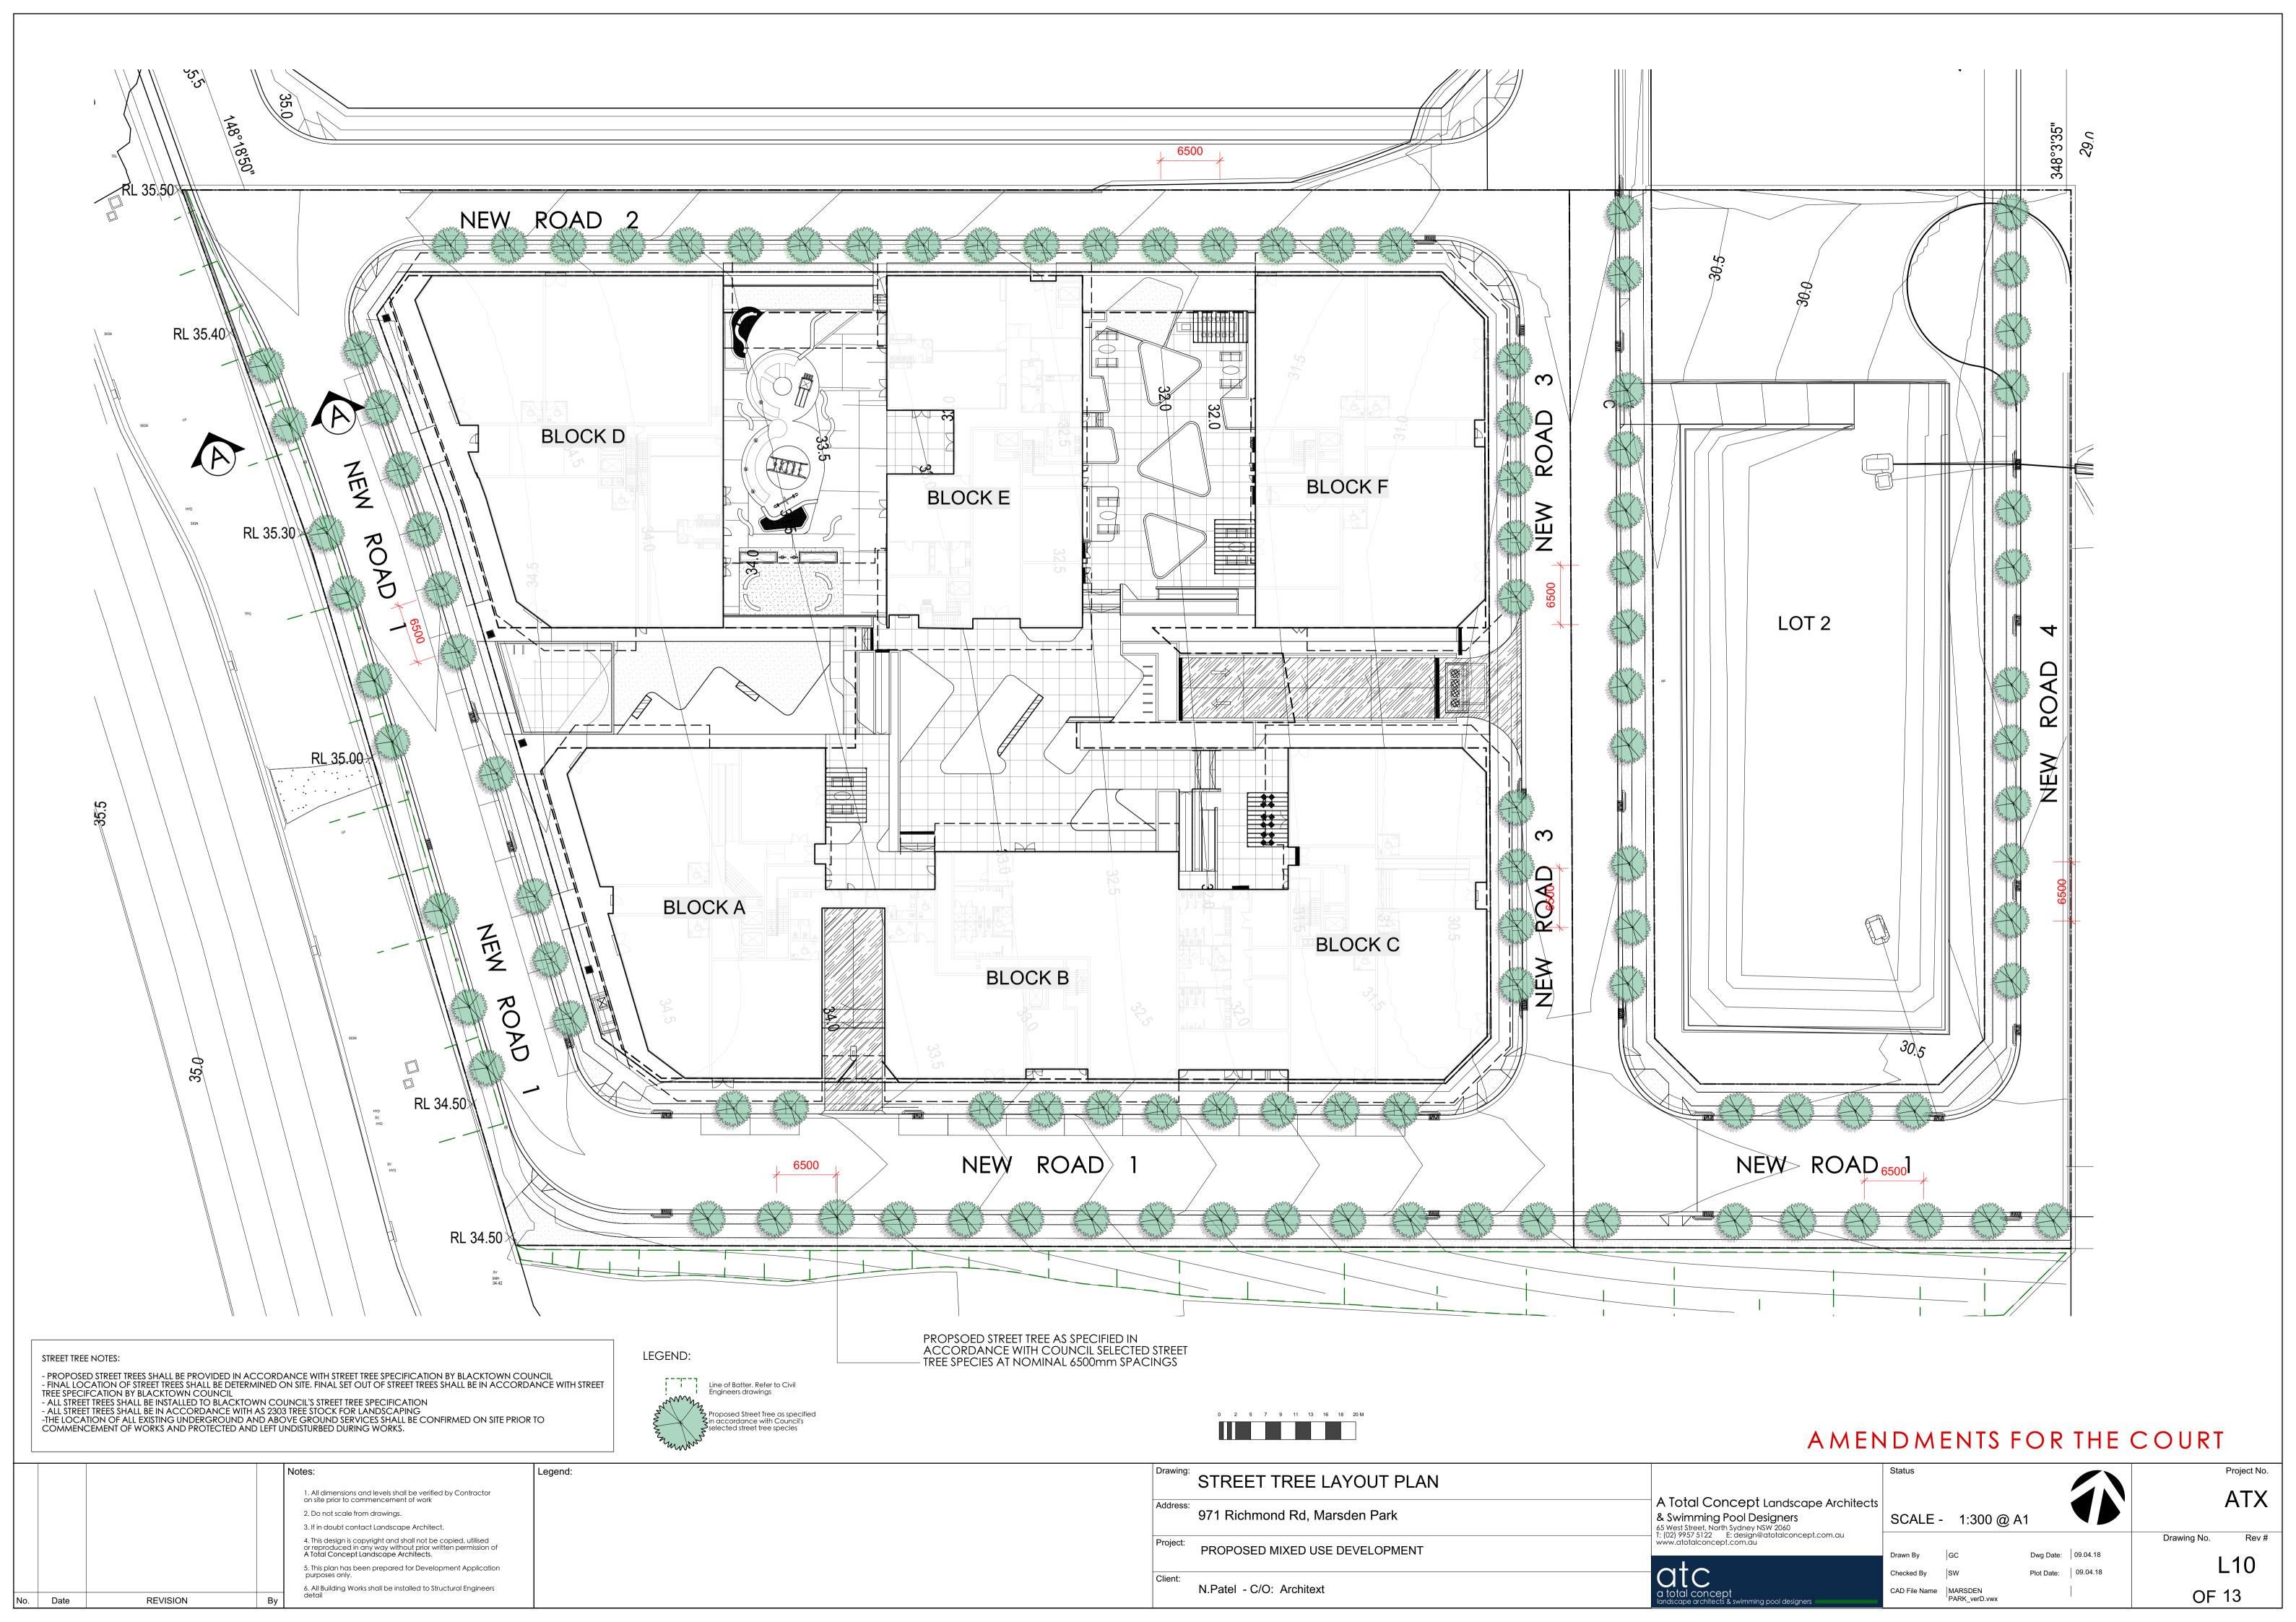

#### PROPOSED STREET TREE SPECIES




Angophora floribunda




Waterhousea floribunda

#### TYPICAL STREET TREE DETAILS

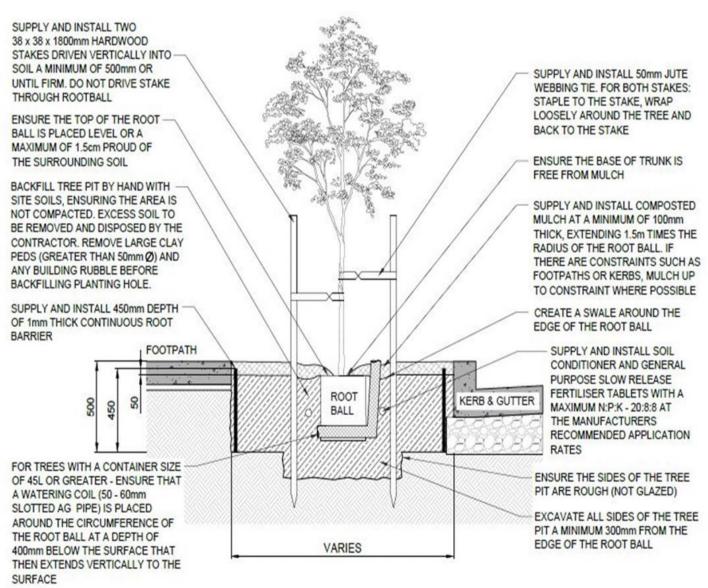

STREET TREE DETAIL AS PROVIDED BY BLACKTOWN COUNCIL

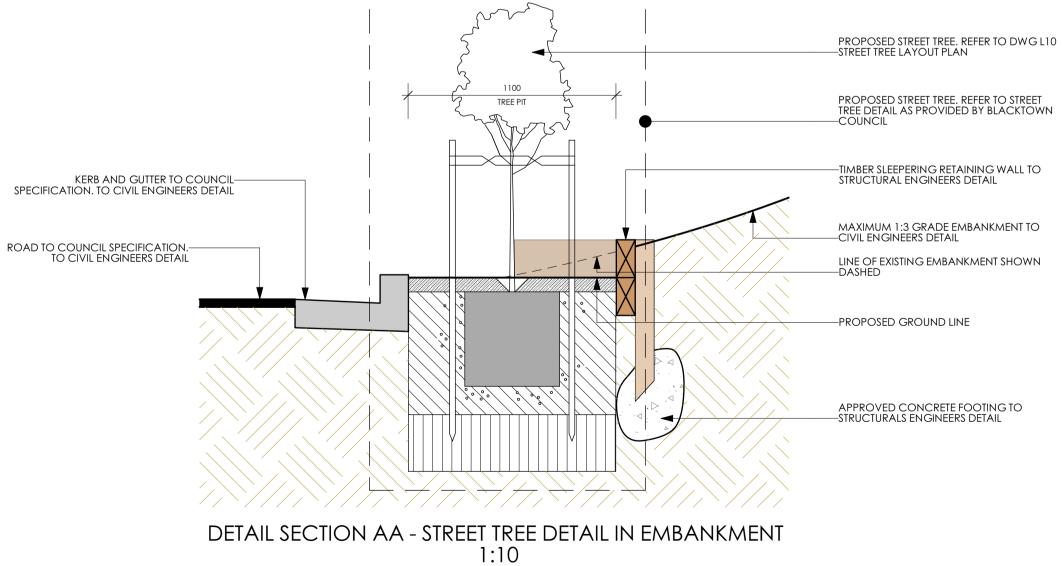

#### TYPICAL STREET TREE SPECIFICTION

#### STREET TREE SPECIFICATION AS PROVIDED BY BLACKTOWN COUNCIL

In order to ensure optimal survival and growth rates for newly planted trees, it is important that planting is carried out in accordance with recommended horticultural practices. Guidelines for tree planting are set out below:

a) Planting Season - Depending on the level of care available, when practicable trees are only to be planted between March and November of each year. However, close consideration should be given to the following points: Optimum planting time is spring or early autumn.

- Bare rooted deciduous species may be planted in winter. - Planting closer to summer will require additional watering, thus adding significantly to costs.

b) Plant Material - Ensure all plants are as per AS 2303:2015 Tree Stock for Landscape Use and have the following attributes; vigorous, true to type, well established, hardened off, of good form, free from disease, have a large healthy root systems and all trees shall have a single leading

c) Tree Size - The minimum size of containerized trees should be:
- Native Species Tube stock - Bushland, Parkland and Open Space Large Beds
- 100 litre - Exotic & Native Species Feature Trees - Parkland and Open Space

- 100 litre – Commercial, Industrial Areas and Residential Flat Buildings

- 45 litre - Residential Areas – Footpaths - 5 litre – Parks & Reserves – Non-feature Planting

d) Rooting Barriers - Install root directors to manufacturer's specifications, to planting in all full width concrete/asphalt footpaths and main streets. Root directors are to be installed for all plantings adjacent to a roadside kerb. See Figure 1 for approved tree planting specification

e) Soil Conditioner - "Terra-Cottem®" or its equivalent is to be incorporated into the planting medium when planting.

f) Watering Dish - Create a small depression around the base of all single tree plantings to act as a water reservoir.

g) Staking - Secure tree loosely to stakes with flexible material, preferably hessian tie or its equivalent, (minimum 25mm wide) wound in "figure of

Residential areas: 2 Hardwood stake 38 x 38 x 1500mm to be installed.
Commercial areas: 2 Hardwood stakes 50 x 50 x 2400mm to be installed.

- Larger species installations should require no staking.

- Staking is to be removed after 12 months or earlier if the trees have established well enough.

h) Additional Considerations-When planting trees in hard pavement areas, use mulch such as pine bark nuggets or its equivalent. In commercial and industrial situations give consideration to the use of tree guards when appropriate. Porous paving is to be used in preference to tree grates which tend to collect litter and require expensive removal and replacement as the tree grows.

i) Consideration for water sensitive urban design in all areas where kerb gutter and footpath replacement is been conducted. It also should be considered that as part of this renewal program that whole street replacement be undertaken.

Tree placement on nature strips - When planting trees, consideration should also be given to avoid planting:

- Within 2-3 metres of any street light.

- Within 2 -3 metres of any vehicle driveway.

Within 6m of the approach side of a bus stop.
Within 3m of the approach side of a road sign or warning sign.
Directly opposite property water mains and not within 1.5 m of such.

Directly behind any stormwater pit and not within 1.5m of such.
Directly on top of stormwater outlet and not within 2m of such.

Directly under overhead service wires (dependent upon tree species).
Within 2-3 metres of water hydrants or sewer inspection pit.

- Within 6m of any roadway corner or intersection.

Within 5m of any pedestrian crossing.
If possible, not to plant tree directly in front of residence front door.
Where a surfaced footpath is present, the tree shall be planted mid-way between the back of

the kerb and the edge of the footpath.

- Where no surfaced footpath exists, the tree shall be planted behind the back edge of the kerb and gutter approximately 650mm to 700mm.

#### 2 Additional Street planting detail and specifications

To aid in the successful delivery of street trees, provide safe public spaces, protect against assets from damage and provide a healthy environment for the tree, the following design measures and specifications are required to be met:

- No timber or steel edging is permissible

- Install root directors to manufacturer' s specifications, to protect assets, structures and/or underground services, to street trees adjoining paths, kerb and gutter or roadways. See Figure 11 for approved root barrier design for newly planted.

- Tree trunk to be a minimum 700mm from street kerb and guttering

- All imported soil to achieve the requirements of AS4419 – Soils For Landscaping All tree planting holes are a minimum 1.5 times diameter and twice the depth of the root ball All mulch is to be free of deleterious material such as rock, soil, weeds and sticks. Acceptable mulch – Forest litter or pine bark mulch

- All soft edges (mulch, turf, grassed) to be finished to appropriate falls and flush with adjacent surface treatment

All soft edges (mulch, turf, grassed) to be finished to appropriate falls and flush with adjacent surface treatment.
Kikuyu is not accepted as a nature strip turf. The use of Soft leafed Buffalo is the preferred turf for nature strip plantings

Turf to consist of 25mm depth of dense, well rooted, vigorous grass growth with minimum 50mm on an average 100mm depth of top soil - Staking is required specified as-drive 2x38x38x1800 mm hardwood stake 600mm into the ground. Secure the stem of the tree firmly with 2 x hessian ties fitted to the stem separately in opposite directions.

- Following prescribed maintenance period, Council will inspect all street trees and provide the applicant with a list of defects which will need to be addressed prior to the acceptance of handover' - The developer must provide to Council in writing one (1) month notice, at minimum, for practical completion inspection and two (2)

month notice for end of maintenance inspection. - Performance of planting will be indicated by new growth with visible sign of new leaves; plants to possess a level of 'greenness'

characteristic with the particular species; Strong floral habit and colour appropriate to the season and species; Absence of dead or damaged foliage, flowers or branches.

#### 3 Post planting specifications

A Maintenance plan for the street trees is to be provided and must contain the following:

a) Watering: Regularly water new trees for at least the first 12 months, particularly during warm, dry periods. During extended dry period's consideration may be given to more mature plantings also receiving water.

Councils Open Space Maintenance Section will be responsible for the weekly watering of new plantings for the first three months following planting. Then once a fortnight watering should continue until the trees establish.

Council will pro-actively seek the cooperation of residents to assist with the watering of newly planted street trees in front of their homes. Council will provide written advice outlining the frequency that these trees should be watered.

There should not be any visible signs of wilting of leaves or stems, with all plants to be fully turgid at all times. There should be no visible sign of over watering such as constantly wet soil, brown leaf margins, stem rot or brown spots on foliage.

b) Weeding: Control weeds around new trees for the first 12 months by hand weeding or herbicide spraying, and by using mulch. Mechanical line trimmers (whipper snippers/ brush cutters) not be used within 300mm of out edge of tree trunks. No grass to overgrow edges where it adjoins hard paved surfaces or kerbs and guttering. No grass or weeds within mulched area in or around tree. Chemical

weed controls not to be applied in extreme temperatures or wind conditions c) Mulching: All garden beds to be re-mulched to maintain a depth of 75mm and level finish with adjacent surfaces. Mulch not to come

into contact with the trunks of trees d) Fertilising: Apply a follow up application of fertiliser at the rate recommended by the manufacturer 12 months after the tree has been planted and at the time of removal of the tree stakes.


e) Formative Pruning: Train new tree plantings by pruning lower branches yearly prior to the prime growing period as required, and keep trees to a single trunk where necessary. Sucker growth is to be removed as part of their regular cycle. Formative pruning of trees to allow effective canopy development and to retain natural or desired shape of the tree is recommended. All damaged dead or diseased wood to be pruned to the nearest lateral shoot or active bud with a clean neat cut as per AS4373:2007 Pruning of amenity trees.

f) Replace: Where possible failed plantings will be replaced with the same species. Stolen trees are to be replaced within one week following notification by council to the developer. Repeated removal of trees within the same location shall immediately be reported to


g) Stakes: Stakes are to be removed after 12 months or sooner if the tree has established well.


SCALE - NTS				AME	NDMENTS FOR THE	COURT
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No. Date REVISION By	y aetaii			landscape architects & swimming pool designers	PARK_verD.vwx	OF 13

#### TYPICAL LANDSCAPE DETAILS

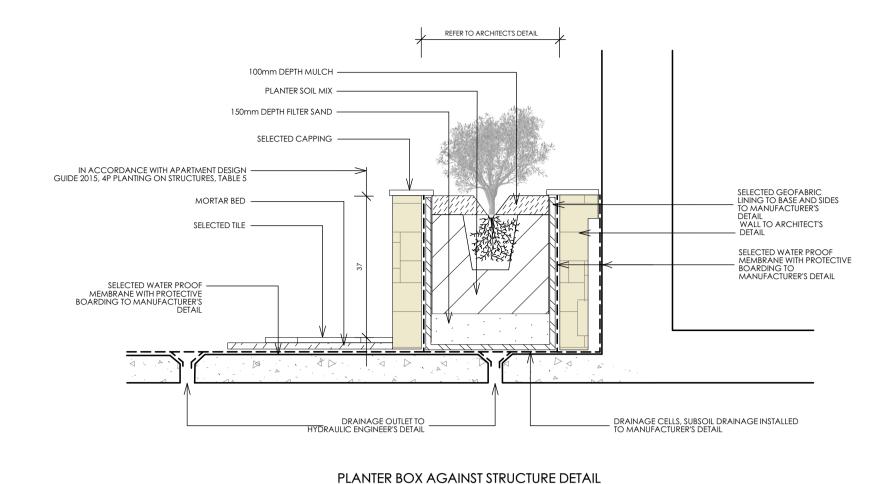

**SCALE 1:20** 

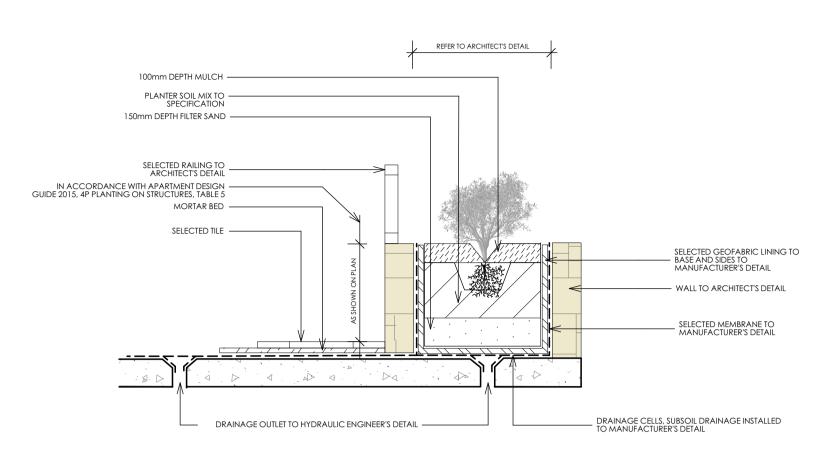

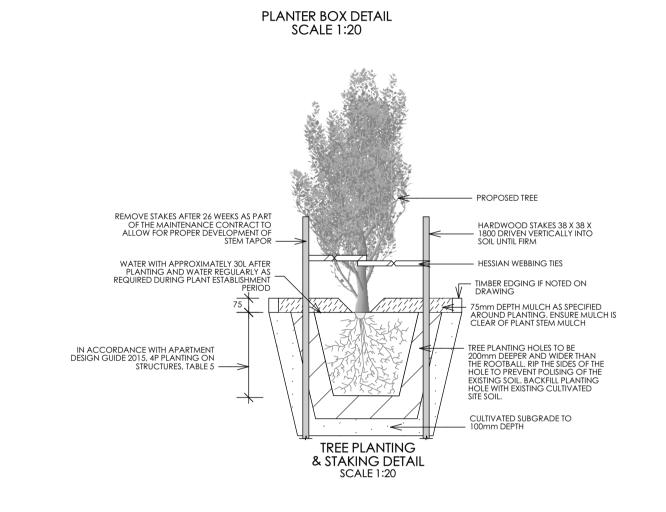


#### MINIMUM SOIL STANDARDS FOR PLANT TYPES AND SIZES

Plant type	Definition	Soil volume	Soil depth	Soil area
Large trees	12-18m high, up to 16m crown spread at maturity	150m³	1,200mm	10m x 10m or equivalent
Medium trees	8-12m high, up to 8m crown spread at maturity	35m³	1,000mm	6m x 6m or equivalent
Small trees	6-8m high, up to 4m crown spread at maturity	9m³	800mm	3.5m x 3.5m or equivalent
Shrubs			500-600mm	
Ground cover			300-450mm	
Turf			200mm	

Note: The above has been calculated assuming fortnightly irrigation. Any sub-surface drainage requirements are in addition to the above minimum soil depths

#### 116 Apartment Design Guide

EXTRACT FROM APARTMENT DESIGN GUIDE 2015, 4P PLANTING ON STRUCTURES, TABLE 5, PAGE 116

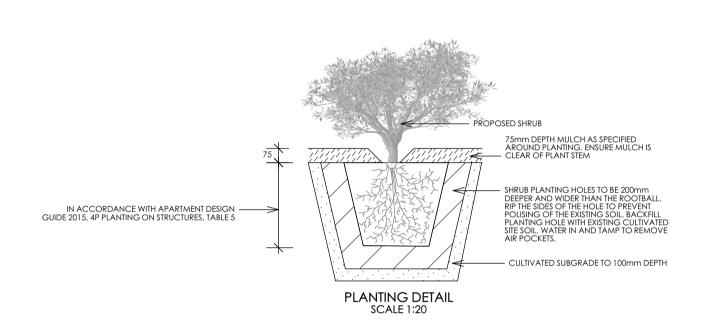

#### OUTLINE LANDSCAPE SPECIFICATION

**Retaining Walls:** Positions, detail and heights of retaining walls shall be by others.

SOIL TO GARDEN AREAS

SCALE 1:20

Preparation by Builder: Builder shall remove all existing concrete pathways, fences, footings, walls etc. not notated to be retained and complete all necessary excavation work prior to commencement on site by Landscape Contractor(). Builder shall ensure that a minimum 450mm of topsoil in garden areas and a minimum 150mm of topsoil in lawn areas exists. Should required depths not exist Builder shall ensure that a minimum 450mm of topsoil in garden areas and a minimum 150mm of topsoil in lawn areas exists. Should required depths not exist Builder shall ensure that a minimum 450mm of topsoil in garden areas and a minimum 150mm of topsoil in lawn areas exists. Should required depths not exist Builder shall ensure that a minimum 450mm of topsoil in garden areas and a minimum 150mm of topsoil in lawn areas exists. Should required depths not exist Builder shall ensure that a minimum 450mm of topsoil in garden areas and a minimum 150mm of topsoil in lawn areas exists. Should required depths not exist Builder shall ensure that a minimum 450mm of topsoil in garden areas exists. Should required depths not exist Builder shall ensure that a minimum 450mm of topsoil in garden areas exists. Should required depths not exist Builder shall ensure that a minimum 450mm of topsoil in garden areas exists. Should required depths not exist Builder shall ensure that a minimum 450mm of topsoil in garden areas exists. Should required depths not exist Builder shall ensure that a minimum 450mm of topsoil in garden areas exists. Should required depths not exist Builder shall ensure that a minimum 450mm of topsoil in garden areas exists. Should required depths not exist Builder shall ensure that a minimum 450mm of topsoil in garden areas exists. Should required a minimum 150mm of topsoil minimum

Tree Protection: Trees to be retained shall be protected during site works and construction by the erection of solid barricades to the specification of Council. Storage of machinery or materials beneath canopy of trees to be retained shall not be permitted unless under direct supervision of Landscape Architect. Existing trees to be retained shall not be permitted unless under direct supervision of Landscape Architect. Existing trees to be retained shall not be permitted unless under direct supervision of trees to be retained shall not be permitted unless under direct supervision of Landscape Architects. Existing trees to be retained shall not be permitted unless under direct supervision of Landscape Architect. Existing trees to be retained shall not be permitted unless under direct supervision of Landscape Architect. Existing trees to be retained shall not be permitted unless under direct supervision of Landscape Architects. Existing trees to be retained shall not be permitted unless under direct supervision of Landscape Architects shall not be permitted unless under the sample of the sample of the project of the sample of the sampl

Planting: Purchase plants from an approved nursery. Plants to be healthy & true to type & species. Set out plants to positions indicated on plan. Followed by 100mm depth of topsoil mix shall then be placed into base of hole and lightly consolidated. Base of hole shall then be watered.

Remove plant container and install plant into hole. Rootball shall be backfilled with surrounding topsoil and topsoil firmed into place. An approved shallow dish shall be thoroughly watered and maintained for the duration of the Contract.

Staking: All trees shall be staked using 2 x 38mm x 38mm x 2000mm long hardwood stakes per plant and with hessian webbing ties instructions.

Mulching: Install 75mm depth of 25mm diameter hardwood mulch to all garden areas, coving mulch down around all plant stems & to finish flush with adjacent surfaces.

Turfing: Prepare for, level & lay cultivated Palmetto Buffulo turves to all areas nominated on plan as being lawn. Roll, water, fertilise, mow & maintain lawns as necessary until completion of maintenance period. At same time make good all existing lawn areas using same lawn type. Lawns in shade shall be over sown with an approved seed mix. Allow to retrim and returf councils nature strip as required. Fencing: Retain all existing fences unless advised otherwise by builder. Install timber paling fences to heights indicated on Plan.

Fencing: Retain all existing fences unless advised otherwise by builder. Install timber paling fences to heights indicated on Plan.

Paving: Areas to be paved shall be excavated or filled to allow for installation of bedding materials. Levels and falls shall be as per Plan. Surface drains with all drains connected to stormwater system and installed by Builder.

Irrigation: Contractor shall supply and install an approved fully automatic, vandal resistant, computerised irrigation system to all garden and lawn areas, excluding council nature strip. Entire system shall be to approval of Water Board and shall utilise pop-up sprinklers and electronic controllers. Contractor shall be responsible to ensure that system is able to satisfactorily operate on available water pressure. Power supply for use by irrigation system shall be provided to an approved location near southwest corner of residence by others and shall consist of an approved weatherproof G.P.O. The irrigation system controllers shall be housed in an approved waterproof cabinet mounted to external wall of residence.

Clotheslines: Contractor shall allow for all necessary labour and materials and shall install clothesline type shall be equal to 'Hills Foldaline'.

Completion: Prior to practical completion remove from site all unwanted debris occurring from work. Satisfy Council that all landscape codes & guidelines.

#### OUTLINE 12 MONTH LANDSCAPE MAINTENANCE PLAN

- CULTIVATED EXISTING SITE SOIL

- EXISTING SUBGRADE

Maintenance Period: A twelve month maintenance period shall be undertaken by owner or owners representative as set out herein. Owner shall have care and maintenance Period. Work shall also include for the care and maintenance of all existing vegetation to be retained and proposed vegetation. Site shall be attended at least weekly and as otherwise required. The following works shall be undertaken during the Maintenance Period.

(a) Recurrent works Undertake recurrent works Undertaken during, report and disease control, returfing, staking and tying, replanting, cultivation, pruning, aerating, renovating, report and disease control, returfing, report and disease control, returring, returring, returning, ret

c) Replacements Immediately replace plants which die or fail to thrive (at discretion of Landscape Architect) with plants of same species or variety and of same species or variety and of same size and quality unless otherwise specified. Plant replacement is required due to vandalism or theft, which shall be at Contractor and shall be paid for by Client at an agreed predetermined rate.

(d) Mulched surfaces Maintain mulched surfaces in clean, tidy, weed-free condition and shall reinstate mulch as necessary to maintain specified depths.
(e) Stakes & ties Adjust and/or replace stakes and ties as required. Remove stakes and ties at end of Maintenance Period if directed by Landscape Architect.

b) Watering Regularly water all plants and lawn areas to maintain optimal growing conditions. Contractor shall adjust the water quantity utilised with regard to climatic conditions prevalent at the time.

(g) Weeding Remove by hand, or by carefully supervised use of weedicide, any weed growth that may occur throughout Maintenance Period. This work shall be executed at weekly intervals so that all lawn and garden areas may be observed in a weed-free condition. (h) Pruning Prune new and existing plants (excluding existing trees) as necessary to maintain dense foliage conditions. Any rogue branches overhanging or obstructing pathways, roads, doorways, etc., shall be removed by approved horticultural methods.

SELECTED LAWN TURE

- TURF UNDERLAY

— EXISTING SUBGRADE

TYPICAL TURF DETAIL SCALE 1:20

(i) Spraying Spraying for insect, fungal and disease attack shall be undertaken as required and in accordance with spray manufacturers recommendations at intervals taking into account the season of year during which landscape works are to be implemented.
(j) Tree Care Should any existing trees be damaged during construction works immediately engage an experienced arboriculturist and then undertake any rectification work recommended by arboriculturist.

	Notes: Legend:	DETAILS & SPECIFICATION	Status	Project No.
	All dimensions and levels shall be verified by Contractor on site prior to commencement of work	A Total Concept Landscape Ard	hitects	ATX
	2. Do not scale from drawings.  3. If in doubt contact Landscape Architect.	971 Richmond Rd, Marsden Park  & Swimming Pool Designers 65 West Street, North Sydney NSW 2060	SCALE - AS NOTED	
	4. This design is copyright and shall not be copied, utilised or reproduced in any way without prior written permission of A Total Concept Landscape Architects.	Project: PROPOSED MIXED USE DEVELOPMENT  T: (02) 9957 5122	Drawn By GC Dwg Date: 09.04.18	Drawing No. Rev#
	5. This plan has been prepared for Development Application purposes only.	Client: N. Betel C/O: Architevt	Checked By SW Plot Date: 09.04.18	L12
No Date	6. All Building Works shall be installed to Structural Engineers detail	N.Patel - C/O: Architext	CAD File Name   MARSDEN   PARK verD.vwx	OF 13